
STATE OF HAWAII DEPARTMENT OF DEFENSE OFFICE OF VETERAN SERVICES

COMMITTAL SHELTER ROOF AND CEILING REPAIRS AND MISCELLANEOUS IMPROVEMENTS


PROJECT NO. CA-1516-C
TAX MAP KEY: 4-5-33:2, 4-5-106:18, 19 & 20
HAWAII STATE VETERANS CEMETERY
45-349 KAMEHAMEHA HWY, KANEOHE, HI 96744

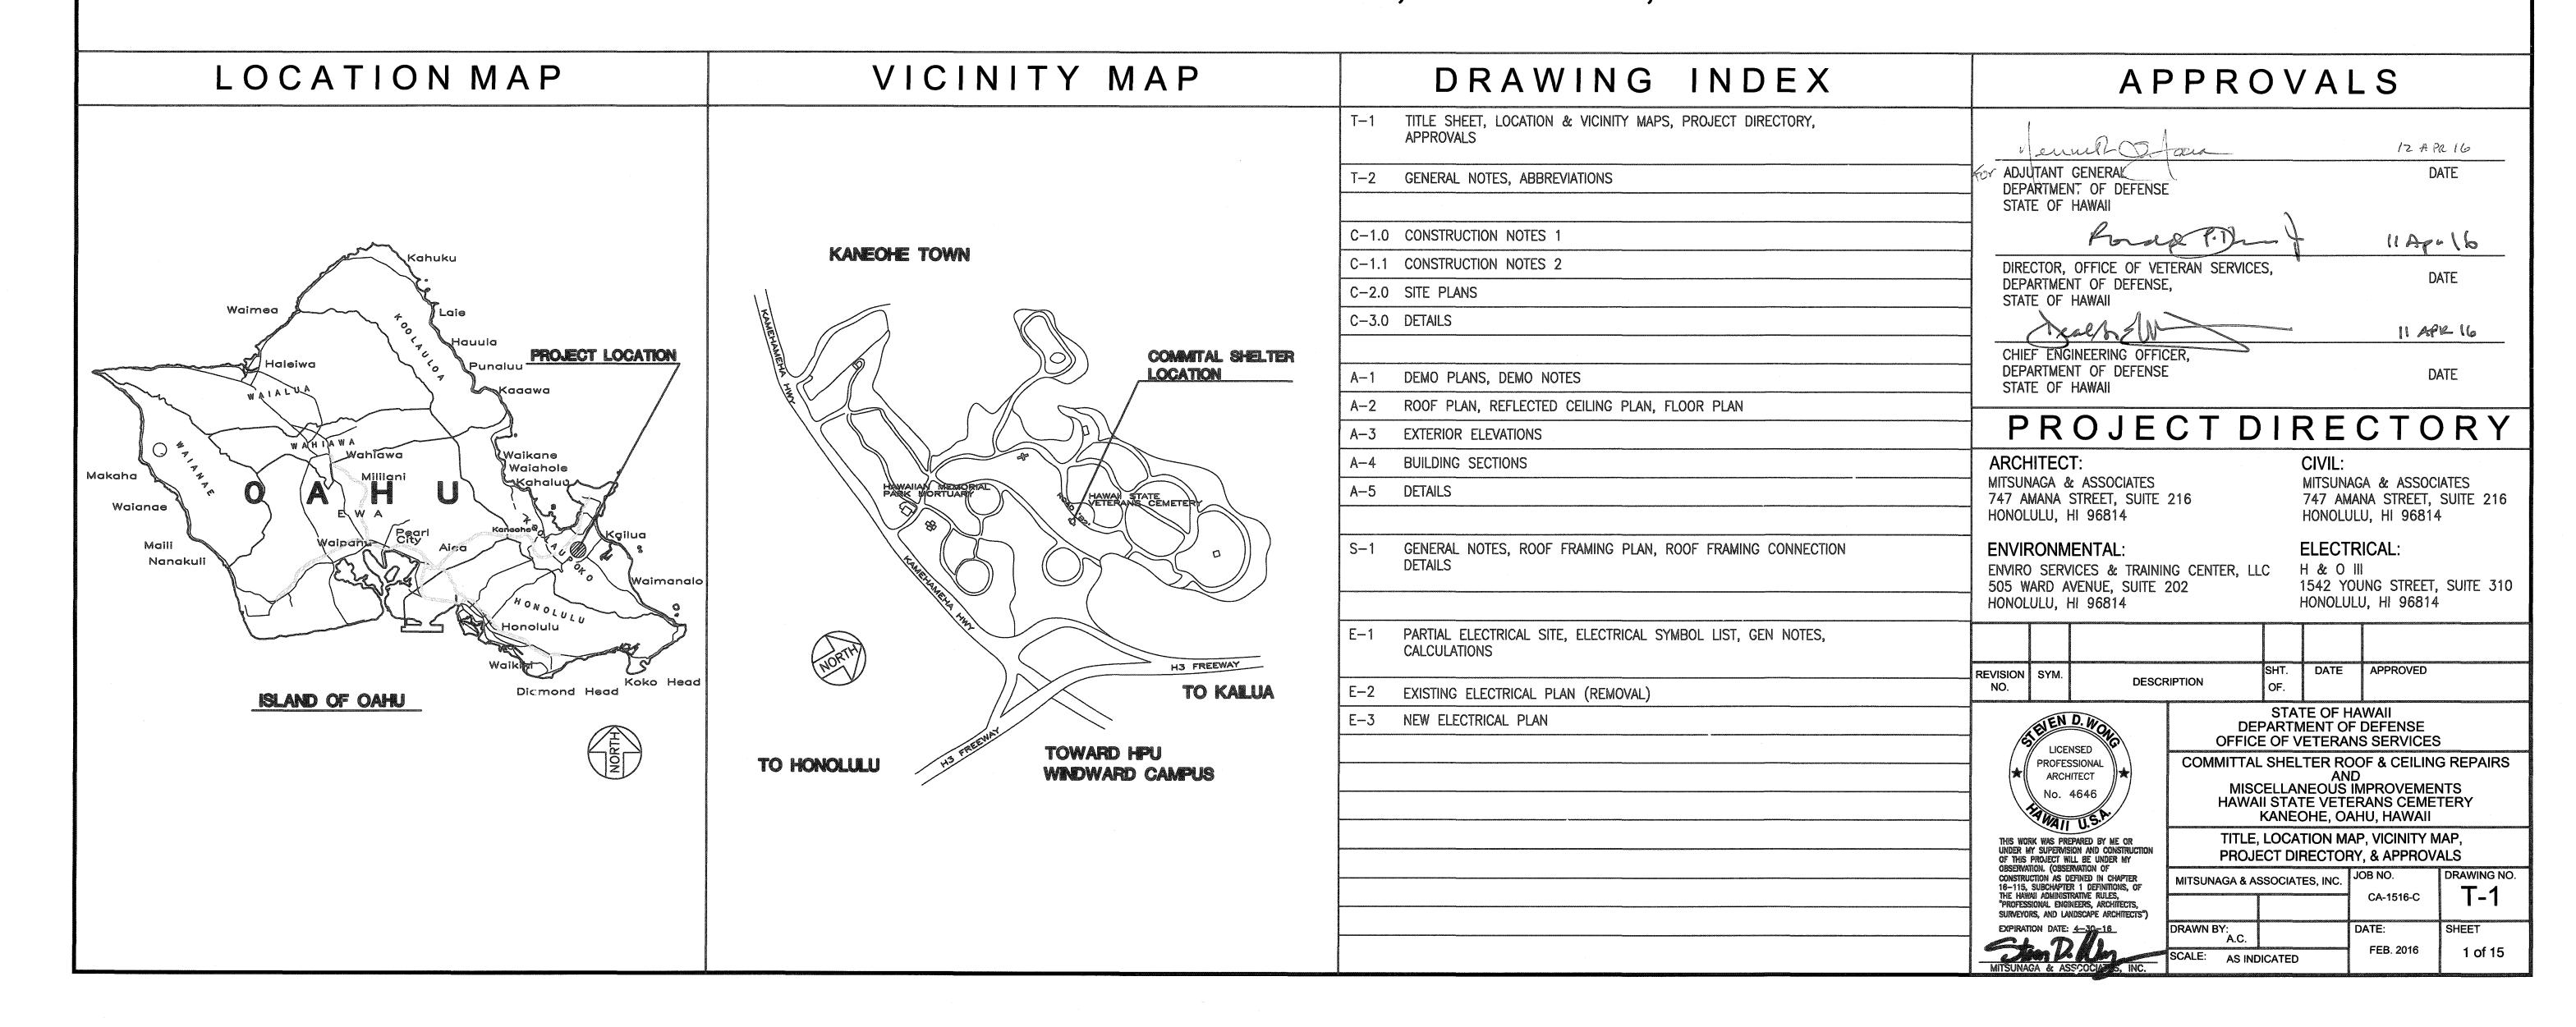

GENERAL NOTES 1 THE SCOPE OF WORK FOR THIS PROJECT CONSISTS OF BUT IS NOT LIMITED TO REPAIRS. IMPROVEMENTS, COMPLETE REROOFING AND CEILING REPLACEMENT FOR THE STRUCTURES SHOWN ON THE DRAWINGS AND DESCRIBED IN THE SPECIFICATIONS. 2 ALL WORK SHALL CONFORM TO THE CURRENT BUILDING CODE, LATEST EDITION AND THE AMENDMENTS OF THE CITY & COUNTY OF HONOLULU. 3 SINCE THIS IS A RENOVATION PROJECT, IT SHALL BE THE SOLE RESPONSIBILITY OF THE CONTRACTOR AND HIS SUBCONTRACTORS TO VISIT THE SITE OF WORK TO FULLY FAMILIARIZE THEMSELVES TO THE EXTENT AND INTENT OF THE WORK SHOWN AND DESCRIBED HEREIN. 4 THE CONTRACTOR SHALL NOTIFY AND COORDINATE WITH THE PROJECT MANAGER ANY MAJOR DEVIATIONS FROM THESE PLANS DUE TO UNFORSEEN OR VARYING FIELD CONDITIONS. 5 ANY CHANGES OR MODIFICATIONS SHALL BE APPROVED IN WRITING BY THE PROJECT MANAGER PRIOR TO THE COMMENCEMENT OF NEW OR ADDITIONAL WORK. 6 UNLESS OTHERWISE SPECIFIED, ALL DETAILS AND DIMENSIONS ARE TYPICAL. 7 ALL WORK SHOWN SHALL BE CONSIDERED NEW WORK. ALL MATERIALS INCORPORATED IN THIS PROJECT SHALL BE NEW MATERIALS UNLESS OTHERWISE SPECIFIED. 8 ALL EXPOSED SURFACES DAMAGED DURING THE COURSE OF CONSTRUCTION SHALL BE REPAIRED AND REPAINTED TO MATCH EXISTING ADJACENT SURFACES AT NO ADDITIONAL COST TO THE OWNER. 9 ALL REMEDIAL REPAIR WORK TO EXISTING CONDITIONS IN THE AREA OF NEW WORK SHALL BE INCLUDED AS PART OF THIS CONTRACT. 10 THE CONTRACTOR SHALL COORDINATE ALL WORK WITH THE PROJECT MANAGER. THE CONTRACTOR MUST GIVE WRITTEN NOTICE TO THE PROJECT MANAGER FOR ANY DEVIATION TO THE ESTABLISHED CONSTRUCTION SCHEDULE. 11 THE CONTRACTOR SHALL CLEAN AND PREPARE ALL NEW AND EXISTING SURFACES AS REQUIRED TO RECEIVE NEW WORK OR AS OTHERWISE REQUIRED FOR A NEAT AND FINISHED APPEARANCE. 12 THE CONTRACTOR SHALL CLEAN AND REMOVE FROM THE PREMESIS, FROM TIME TO TIME, ALL DEBRIS ACCUMULATED FROM OPERATION.

ABBREVIATIONS

A BOVE ABOVE ACC ACCESSIBLE ACOUS ACOUSTICAL GOLD CONTRACTOR G							1			
	ACUS AFF ACTM. & V. @ D. K. B. C.	ACOUNT AC	ESSIBLE USTICAL USTABLE USTABL	O OO FEFEL RR	GAG GYBD KBBURTH J L AMYTO MAYTO NYN BOODEGD PYMSDLING REEGERR	GENERAL CONTRACTOR GLASS GYPSUM GYPBOARD HOLLOW CORE HARD BOARD HARDWOOD HARDWARE HEIGHT HANDRAILING INSULATION INTERIOR JOINT LAMINATED LAVATORY LIGHT LONG LEG OUT MACHINE MAXIMUM MECHANICAL METAL MANUFACTURER MINIMUM MOUNTED MOUNTING MATERIAL NUMBER NOT TO SCALE NOT IN CONTRA OBSCURE ON CENTER OUTSIDE DIAME OFFICE OPENING OVERHEAD PRINTER PAVEMENT PLASTIC LAMINA PLASTIC LAMINA PLASTER PLYWOOD PANEL PARTITION POLYVINYL CHLORIDE ROOF DRAIN RECESSED REFLECTED RESILIENT ROOM	TI ACT	SECH DETTING TO A SECH DETTING TO A SECH DETTING A	SPLASI SOLID SOAP SECTION SCHED SOAP SECTION SUPPORT SIMILAR STAND, STAN	CORE DULE DISPENSE ON HING RESS STEE ARD GE TURAL NDED VINYL TRICAL MEST AND GREEN AND
REVISION NO. SYM. DESCRIPTION SHT. DATE APPROVED OF.	R R	SYM.	DI	ESCRIP	PTION		DATE	APPRO	OVED	

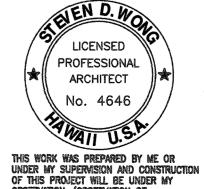

OBSERVATION. (OBSERVATION OF CONSTRUCTION AS DEFINED IN CHAPTER 16-115, SUBCHAPTER 1 DEFINITIONS, OF THE HAWAII ADMINISTRATIVE RULES, "PROFESSIONAL ENGINEERS, ARCHITECTS, CHARVAGE AND LANDERAGE ARCHITECTS.

SURVEYORS, AND LANDSCAPE ARCHITECTS")

DEPARTMENT OF DEFENSE OFFICE OF VETERANS SERVICES

COMMITTAL SHELTER ROOF & CEILING REPAIRS
AND
MISCELLANEOUS IMPROVEMENTS
HAWAII STATE VETERANS CEMETERY

HAWAII STATE VETERANS CEMETERY KANEOHE, OAHU, HAWAII GENERAL NOTES, ABBREVIATIONS

	SSOCIATES, INC.	JOB NO. CA-1516-C	T-2	
DRAWN BY: A.C.		DATE:	SHEET	
SCALE: AS IND	DICATED	FEB. 2016	2 of 15	

GENERAL CONSTRUCTION NOTES:


- 1. ALL APPLICABLE CONSTRUCTION WORK SHALL BE DONE IN ACCORDANCE WITH THE STANDARD SPECIFICATIONS FOR PUBLIC WORKS CONSTRUCTION, SEPTEMBER 1986 AND STANDARD DETAILS FOR PUBLIC WORKS CONSTRUCTION, SEPTEMBER 1984, AS AMENDED, OF THE DEPARTMENT OF PUBLIC WORKS, CITY AND COUNTY OF HONOLULU AND THE COUNTIES OF KAUAI, MAUI, AND HAWAII.
- 2. THE UNDERGROUND PIPES, CABLES OR DUCTLINES KNOWN TO EXIST FROM SEARCH OF RECORDS ARE INDICATED ON THE PLANS. THE CONTRACTOR SHALL VERIFY THE LOCATIONS AND DEPTHS OF THE FACILITIES AND EXERCISE PROPER CARE IN EXCAVATING IN THE AREA. WHEREVER CONNECTIONS OF NEW UTILITIES TO EXISTING UTILITIES ARE SHOWN ON THE PLANS, THE CONTRACTOR SHALL EXPOSE THE EXISTING LINES AT THE PROPOSED CONNECTIONS TO VERIFY THEIR LOCATIONS AND DEPTHS PRIOR TO EXCAVATION FOR THE NEW LINES.
- 3. NO CONTRACTOR SHALL PERFORM ANY CONSTRUCTION OPERATION SO AS TO CAUSE FALLING ROCKS, SOIL OR DEBRIS IN ANY FORM TO FALL, SLIDE OR FLOW INTO EXISTING DRAINAGE SYSTEMS, OR ADJOINING PROPERTIES, STREETS OR NATURAL WATERCOURSES. SHOULD SUCH VIOLATIONS OCCUR, THE CONTRACTOR MAY BE CITED AND THE CONTRACTOR SHALL IMMEDIATELY MAKE ALL REMEDIAL ACTIONS NECESSARY.
- 4. THE GENERAL CONTRACTOR OF THE PROJECT SHALL BE RESPONSIBLE FOR CONFORMANCE WITH APPLICABLE PROVISIONS OF THE HAWAII ADMINISTRATIVE RULE, TITLE 11, CHAPTER 54, "WATER QUALITY STANDARDS," AND TITLE, CHAPTER 55, "WATER POLLUTION CONTROL," AS WELL AS CHAPTER 14 OF THE REVISED ORDINANCES OF HONOLULU, AS AMENDED. BEST MANAGEMENT PRACTICES SHALL BE EMPLOYED AT ALL TIMES DURING CONSTRUCTION.

IN ACCORDANCE WITH STATE LAW, ALL DISCHARGES RELATED TO PROJECT CONSTRUCTION OR OPERATIONS ARE REQUIRED TO COMPLY WITH STATE WATER QUALITY STANDARDS (HAWAII ADMINISTRATIVE RULES, CHAPTER 11-54). BEST MANAGEMENT PRACTICES SHALL BE USED TO MINIMIZE OR PREVENT THE DISCHARGE OF SEDIMENT, DEBRIS, AND OTHER POLLUTANTS TO STATE WATERS.

- 5. THE CONTRACTOR SHALL SUBMIT A BMP CONSTRUCTION PLAN TO THE PROJECT MANAGER FOR APPROVAL THE BMP PLAN SHALL DESCRIBE ALL BMP'S TO BE USED IN ALL PORTIONS OF THE PROJECT.
- 6. PURSUANT TO CHAPTER 6E, HRS, IN THE EVENT ANY ARTIFACTS OR HUMAN REMAINS ARE UNCOVERED DURING CONSTRUCTION OPERATIONS, THE CONTRACTOR SHALL IMMEDIATELY SUSPEND WORK AND NOTIFY THE HONOLULU POLICE DEPARTMENT, THE STATE DEPARTMENT OF LAND AND NATURAL RESOURCES—HISTORIC PRESERVATION DIVISION (692–8015).
- 7. THE EXISTING UTILITIES HAVE BEEN SHOWN ON THESE PLANS INSOFAR AS IT IS POSSIBLE TO DO SO. THEIR LOCATIONS AS SHOWN ARE APPROXIMATE ONLY AND THE CONTRACTOR SHALL MAKE INDEPENDENT CHECK ON THE GROUND BY PROBING AND WITH THE VARIOUS UTILITY COMPANIES AND GOVERNMENTAL AGENCIES TO ASCERTAIN THEIR EXACT LOCATIONS. IF UTILITIES NOT SHOWN ARE SUSPECTED, REQUIRE TONING OF THESE AREAS PRIOR TO EXCAVATION TO LOCATE THEM.
- 8. THE CONTRACTOR SHALL PROTECT ALL EXISTING UTILITIES WHETHER SHOWN ON THE PLANS OR NOT. BEFORE DISRUPTING SERVICE OF ANY UTILITY, THE CONTRACTOR SHALL CONTACT THE PROJECT MANAGER AND APPROPRIATE RESPONSIBLE UTILITY AUTHORITY. DAMAGE TO EXISTING UTILITIES AS A RESULT OF CONSTRUCTION ACTIVITIES SHALL BE REPAIRED BY THE CONTRACTOR AT NO ADDITIONAL COST TO THE STATE.
- 9. THE CONTRACTOR MAY ARRANGE WITH THE PROJECT MANAGER TO USE ON-SITE WATER & ELECTRICITY.
- 10. ALL EXISTING UTILITIES TO REMAIN IN USE, WHETHER OR NOT SHOWN ON THE PLANS, SHALL BE PROTECTED AT ALL TIMES BY THE CONTRACTOR DURING CONSTRUCTION UNLESS SPECIFIED ON THE PLANS TO BE ABANDONED. ANY DAMAGE TO THE EXISTING UTILITIES SHALL BE REPAIRED AND PAID FOR BY THE CONTRACTOR.
- 11. UNLESS RELOCATION IS CALLED FOR ON THE PLANS, EXISTING UTILITIES SHALL REMAIN IN—SERVICE AND IN PLACE. IF RELOCATION OF EXISTING UTILITIES IS REQUIRED FOR THE CONTRACTOR'S CONVENIENCE, INTERRUPTION OF SERVICE SHALL BE KEPT TO A MINIMUM AND SHALL BE DONE AT THE CONTRACTOR'S EXPENSE AND ONLY WITH THE APPROVAL OF THE PROJECT MANAGER.
- 12. THE CONTRACTOR SHALL VERIFY AND CHECK ALL DIMENSIONS AND DETAILS SHOWN ON THE DRAWINGS PRIOR TO THE START OF CONSTRUCTION. ANY DISCREPANCY SHALL BE IMMEDIATELY BROUGHT TO THE ATTENTION OF THE PROJECT MANAGER FOR CLARIFICATION.
- 13. THE EXISTING IMPROVEMENTS ON THE PREMISES AND IN ADJACENT AREA THAT ARE NOT TO BE REMOVED, SHALL BE PRESERVED AND PROTECTED. ANY AND ALL DAMAGES RESULTING FROM THE CONTRACTOR'S CONSTRUCTION OPERATION SHALL BE REPLACED AND REPAIRED TO ORIGINAL CONDITION, AT NO ADDITIONAL COST TO THE STATE/OWNER.
- 14. THE CONTRACTOR SHALL BE RESPONSIBLE FOR CLEANING AND RESTORATION TO ORIGINAL OR BETTER CONDITION, NEARBY IMPROVEMENTS AFFECTED BY DUST AND/OR OTHER REASONS RESULTING FROM THE CONSTRUCTION ACTIVITY.
- 15. IT SHALL BE THE CONTRACTOR'S RESPONSIBILITY TO NOTIFY THE PROJECT MANAGER FOR ANY AND ALL DISCREPANCIES FOUND ON THE DRAWINGS OR SPECIFICATIONS PRIOR TO THE BID OPENING. ANY DISCREPANCIES OR QUESTIONS RAISED AFTER THE BID OPENING THAT MAY RESULT IN EXTRA COST SHALL BE BORNE BY THE CONTRACTOR.

INDEX

CIVIL:			SHEET NO
CONSTRUCTION	NOTES	1	C-1.0
CONSTRUCTION	NOTES	2	C-1.1
SITE PLANS			C-2.0
DETAILS			C = 3.0

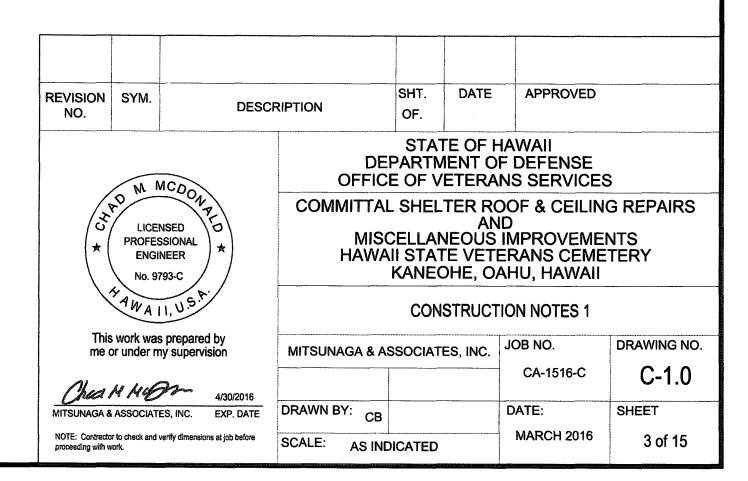


GRADING NOTES


- 1. ALL GRADING WORK SHALL BE DONE IN ACCORDANCE WITH CHAPTER 14, ARTICLES 13, 14, 15 AND 16, AS RELATED TO GRADING, SOIL EROSION AND SEDIMENT CONTROL OF THE REVISED ORDINANCES OF HONOLULU, 1990, AS AMENDED.
- 2. NO CONTRACTOR SHALL PERFORM ANY GRADING OPERATION SO AS TO CAUSE FALLING ROCKS, SOIL OR DEBRIS IN ANY FORM TO FALL, SLIDE OR FLOW ONTO ADJOINING PROPERTIES, STREETS OR NATURAL WATERCOURSES. SHOULD SUCH VIOLATIONS OCCUR, THE CONTRACTOR MAY BE CITED AND THE CONTRACTOR SHALL IMMEDIATELY MAKE ALL REMEDIAL ACTIONS NECESSARY.
- 3. THE CONTRACTOR, AT HIS OWN EXPENSE, SHALL KEEP THE PROJECT AREA AND SURROUNDING AREA FREE FROM DUST NUISANCE. THE WORK SHALL BE IN CONFORMANCE WITH THE AIR POLLUTION CONTROL STANDARDS CONTAINED IN THE HAWAII ADMINISTRATIVE RULES, TITLE 11, CHAPTER 60.1, "AIR POLLUTION CONTROL".
- 4. ADEQUATE PROVISIONS SHALL BE MADE TO PREVENT SURFACE WATERS FROM DAMAGING THE CUT FACE OF AN EXCAVATION OR THE SLOPED SURFACES OF A FILL. FURTHERMORE, ADEQUATE PROVISIONS SHALL BE MADE TO PREVENT SEDIMENT—LADEN RUNOFF FROM LEAVING THE SITE.
- 5. ALL SLOPES AND EXPOSED AREAS SHALL BE SODDED OR PLANTED AS SOON AS FINAL GRADES HAVE BEEN ESTABLISHED. PLANTING SHALL NOT BE DELAYED UNTIL ALL GRADING WORK HAS BEEN COMPLETED. GRADING TO FINAL GRADE SHALL BE CONTINUOUS, AND ANY AREA WITHIN WHICH WORK HAS BEEN INTERRUPTED OR DELAYED SHALL BE PLANTED.
- 6. THE LIMITS OF THE AREA TO BE GRADED SHALL BE FLAGGED BEFORE THE COMMENCEMENT OF THE GRADING WORK.
- 7. ALL GRADING OPERATIONS SHALL BE PERFORMED IN CONFORMANCE WITH THE APPLICABLE PROVISIONS OF THE WATER QUALITY AND WATER POLLUTION CONTROL STANDARDS CONTAINED IN HAWAII ADMINISTRATIVE RULES, TITLE 11, CHAPTER 54, "WATER QUALITY STANDARDS", AND TITLE 11, CHAPTER 55, "WATER POLLUTION CONTROL".
- 8. WHERE APPLICABLE AND FEASIBLE THE MEASURES TO CONTROL EROSION AND OTHER POLLUTANTS SHALL BE IN PLACE BEFORE ANY EARTH MOVING PHASE OF THE GRADING IS INITIATED.
- 9. TEMPORARY EROSION CONTROLS SHALL NOT BE REMOVED BEFORE PERMANENT EROSION CONTROLS ARE IN-PLACE AND ESTABLISHED.
- 10. IF THE GRADING WORK INVOLVES CONTAMINATED SOIL, THEN ALL GRADING WORK SHALL BE DONE IN CONFORMANCE WITH APPLICABLE STATE AND FEDERAL REQUIREMENTS.
- 11. PURSUANT TO CHAPTER 6E, HRS, IN THE EVENT ANY ARTIFACTS OR HUMAN REMAINS ARE UNCOVERED DURING CONSTRUCTION OPERATIONS, THE CONTRACTOR SHALL IMMEDIATELY SUSPEND WORK AND NOTIFY THE HONOLULU POLICE DEPARTMENT, THE STATE DEPARTMENT OF LAND AND NATURAL RESOURCES—HISTORIC PRESERVATION DIVISION (692–8015).
- 12. ALL GRADING AND CONSTRUCTION WORK SHALL IMPLEMENT MEASURES TO ENSURE THAT THE DISCHARGE OF POLLUTANTS FROM THE CONSTRUCTION SITE WILL BE REDUCED TO THE MAXIMUM EXTENT PRACTICABLE AND WILL NOT CAUSE OR CONTRIBUTE TO AN EXCEEDANCE OF WATER QUALITY STANDARDS.
- 13. NON-COMPLIANCE TO ANY OF THE ABOVE REQUIREMENTS SHALL MEAN IMMEDIATE SUSPENSION OF ALL WORK, AND REMEDIAL WORK SHALL COMMENCE IMMEDIATELY. ALL COSTS INCURRED SHALL BE BILLED TO THE VIOLATOR. FURTHERMORE, VIOLATORS SHALL BE SUBJECTED TO ADMINISTRATIVE, CIVIL AND/OR CRIMINAL PENALTIES.


PUBLIC HEALTH SAFETY & CONVENIENCE NOTES


- 1. THE CONTRACTOR SHALL OBSERVE AND COMPLY WITH ALL FEDERAL, STATE AND LOCAL LAWS REQUIRED FOR THE PROTECTION OF PUBLIC HEALTH, SAFETY AND ENVIRONMENTAL QUALITY.
- 2. THE CONTRACTOR, AT HIS OWN EXPENSE, SHALL KEEP THE PROJECT AND ITS SURROUNDING AREAS FREE FROM DUST NUISANCE. THE WORK SHALL BE IN CONFORMANCE WITH THE AIR POLLUTION STANDARDS AND REGULATIONS OF THE STATE DEPARTMENT OF HEALTH.
- 3. THE CONTRACTOR SHALL PROVIDE, INSTALL AND MAINTAIN ALL NECESSARY SIGNS, LIGHTS, FLARES, BARRICADES, MARKERS, CONES AND OTHER PROTECTIVE FACILITIES AND SHALL TAKE ALL NECESSARY PRECAUTIONS FOR THE PROTECTION, CONVENIENCE AND SAFETY OF THE PUBLIC.
- 4. THE CONTRACTOR'S ATTENTION IS DIRECTED TO TITLE 11, DEPARTMENT OF HEALTH, CHAPTER 46, COMMUNITY NOISE CONTROL, IN WHICH MAXIMUM ALLOWABLE NOISE LEVELS HAVE BEEN SET. IF THE CONSTRUCTION WILL BE REQUIRED TO OBTAIN A PERMIT FROM THE DIRECTOR OF THE DEPARTMENT OF HEALTH, THE CONTRACTOR SHALL OBTAIN A COPY OF CHAPTER 46 AND BECOME FAMILIAR WITH THE NOISE LEVEL RESTRICTIONS AND THE PROCEDURES FOR OBTAINING A PERMIT FOR CONSTRUCTION ACTIVITIES. APPLICATION AND INFORMATION ON VARIANCES FROM THE ENVIRONMENTAL HEALTH SERVICES DIVISION, 591 ALA MOANA BLVD., RM. 125, HONOLULU, HAWAII OR BY TELEPHONE 586-4576.
- WHERE PEDESTRIAN WALKWAYS EXIST, THEY SHALL BE MAINTAINED IN PASSABLE CONDITION OR OTHER FACILITIES FOR PEDESTRIANS SHALL BE PROVIDED. TEMPORARY PASSAGE WAYS SHALL BE ACCESSIBLE AND COMPLY WITH THE GUIDELINES BELOW:
 - A. ADAAG 201.3 TEMPORARY AND PERMANENT STRUCTURES. THESE REQUIREMENTS SHALL APPLY TO TEMPORARY AND PERMANENT BUILDINGS AND FACILITIES
 - B. ADAAG 206.1 GENERAL. ACCESSIBLE ROUTES SHALL BE PROVIDED IN ACCORDANCE WITH 206 AND SHALL COMPLY WITH CHAPTER 4.
- CONTRACTOR SHALL TEMPORARILY SUSPEND WORK DURING BURIAL/MEMORIAL SERVICES AND RELATED ACTIVITIES, AS DIRECTED BY THE CEMETERY MANAGER. BURIALS OCCUR, ON AVERAGE, THREE (3) TIMES PER DAY. WITH EACH BURIAL HAVING AN APPROX. DURATION OF 20 TO 30 MINUTES. THE CONTRACTOR SHALL INCLUDED THE COST OF SUCH STOPPAGES OF WORK IN THE BID AMOUNT. NO ADDITIONAL COMPENSATION WILL BE PROVIDED FOR THE CONTRACTORS LACK OF ACCOMMODATING SUCH STOPPAGES IN THEIR BID.
- 7. THE CEMETERY RESTROOM FACILITY WILL BE AVAILABLE FOR USE DURING CONSTRUCTION. THE FACILITIES SHALL BE KEPT CLEAN AND MAINTAINED IN A CONDITION ACCEPTABLE WITH THE CEMETERY MANAGER. ABUSE OF THIS PRIVILEGE WILL RESULT IN THE REVOCATION OF THE USE OF THE FACILITIES, AND THE CONTRACTOR WILL BE REQUIRED TO PROVIDE TEMPORARY FACILITIES AT NO ADDITIONAL COST TO THE STATE.


<u>ABBREVIAT</u>	TIONS:				
AC ADA	ASPHALTIC CONCRETE AMERICANS WITH DISABILITIES ACT	MAX MH MISC MIN	MAXIMUM MANHOLE MISCELLANEOUS MINIMUM		
& APPROX ASTM	AND APPROXIMATE, APPROXIMATELY AMERICAN SOCIETY FOR TESTING MATERIALS	N NTS NO	NORTH NOT TO SCALE NUMBER		
0	AT	OC OD O/S	ON CENTER OUTSIDE DIAMETER OFFSET		
B, BOT BW BWS BC	BOTTOM BOTTOM OF WALL BOARD OF WATER SUPPLY BOTTOM OF CURB	PCC PAV'T PSF PI	PORTLAND CEMENT CONCRETE PAVEMENT		
CONN © CONC	CONNECT, CONNECTION CENTERLINE CONCRETE	PL PVC	PROPERTY LINE, PLACE POLYVINYL CHLORIDE		
CONT COTG	CONTINUE, CONTINUOUS CLEAN OUT TO GRADE	PJF	PRE-MOLDED JOINT FILLER		
CY DET DIA DI	CUBIC YARD DETAIL DIAMETER DRAIN INLET	R REQ'D REINF REV	RADIUS REQUIRED REINFORCEMENT REVISION/REVISED		
DMH DPP	DRAIN MANHOLE DEPARTMENT OF PLANNING & PERMITTING	SCH SF SHT	SCHEDULE SQUARE FOOT		
DPW DS DWG	DPW DEPARTMENT OF PUBLIC WORKS DS DOWN SPOUT DWG DRAWING EA EACH ELEC ELECTRIC, ELECTRICAL EP EDGE OF PAVEMENT ELEVATION EQ EQUAL EW EACH WAY		SHEET SEWER LINE SEWER MANHOLE SPECIFICATION		
EP ELEV, EL EQ EW			SQUARE STAINLESS STEEL STATION STANDARD SQUARE YARD		
EXIST EX.TC EX.BC	EXISTING TOP OF CURB	T THK TOF	TOP THICK TOP OF FOOTING		
FT FH FFE FG	FH FIRE HYDRANT FFE FINISH FLOOR ELEVATION	TW TC TS TYP	TOP OF WALL TOP OF CURB TOP OF STAIR TYPICAL		
GALV GV	GALVANIZED GATE VALVE	VB VERT	VALVE BOX VERTICAL		
HORIZ HP	HORIZONTAL HIGH POINT	W WL	WATER WATER MANUALE		
ID INV	INSIDE DIAMETER INVERT	WMH WM WV	WATER MANHOLE WATER METER WATER VALVE		
LAT LF LB(S)	LATERAL LINEAR FOOT POUND(S)	WWF	WELDED WIRE FABRIC		

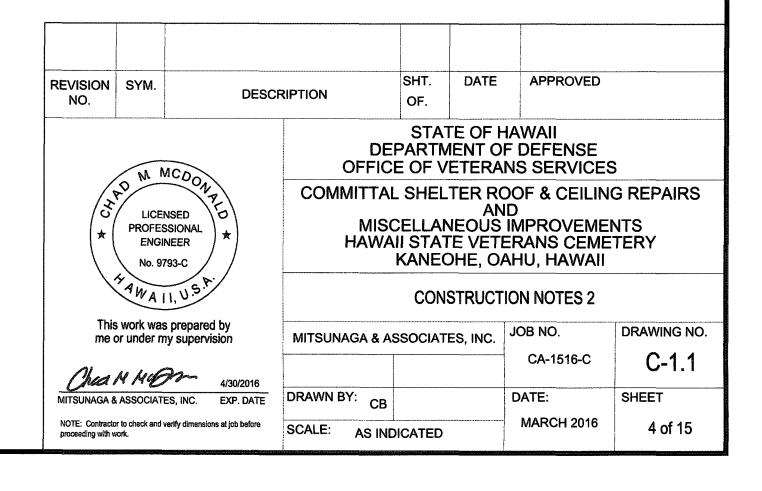

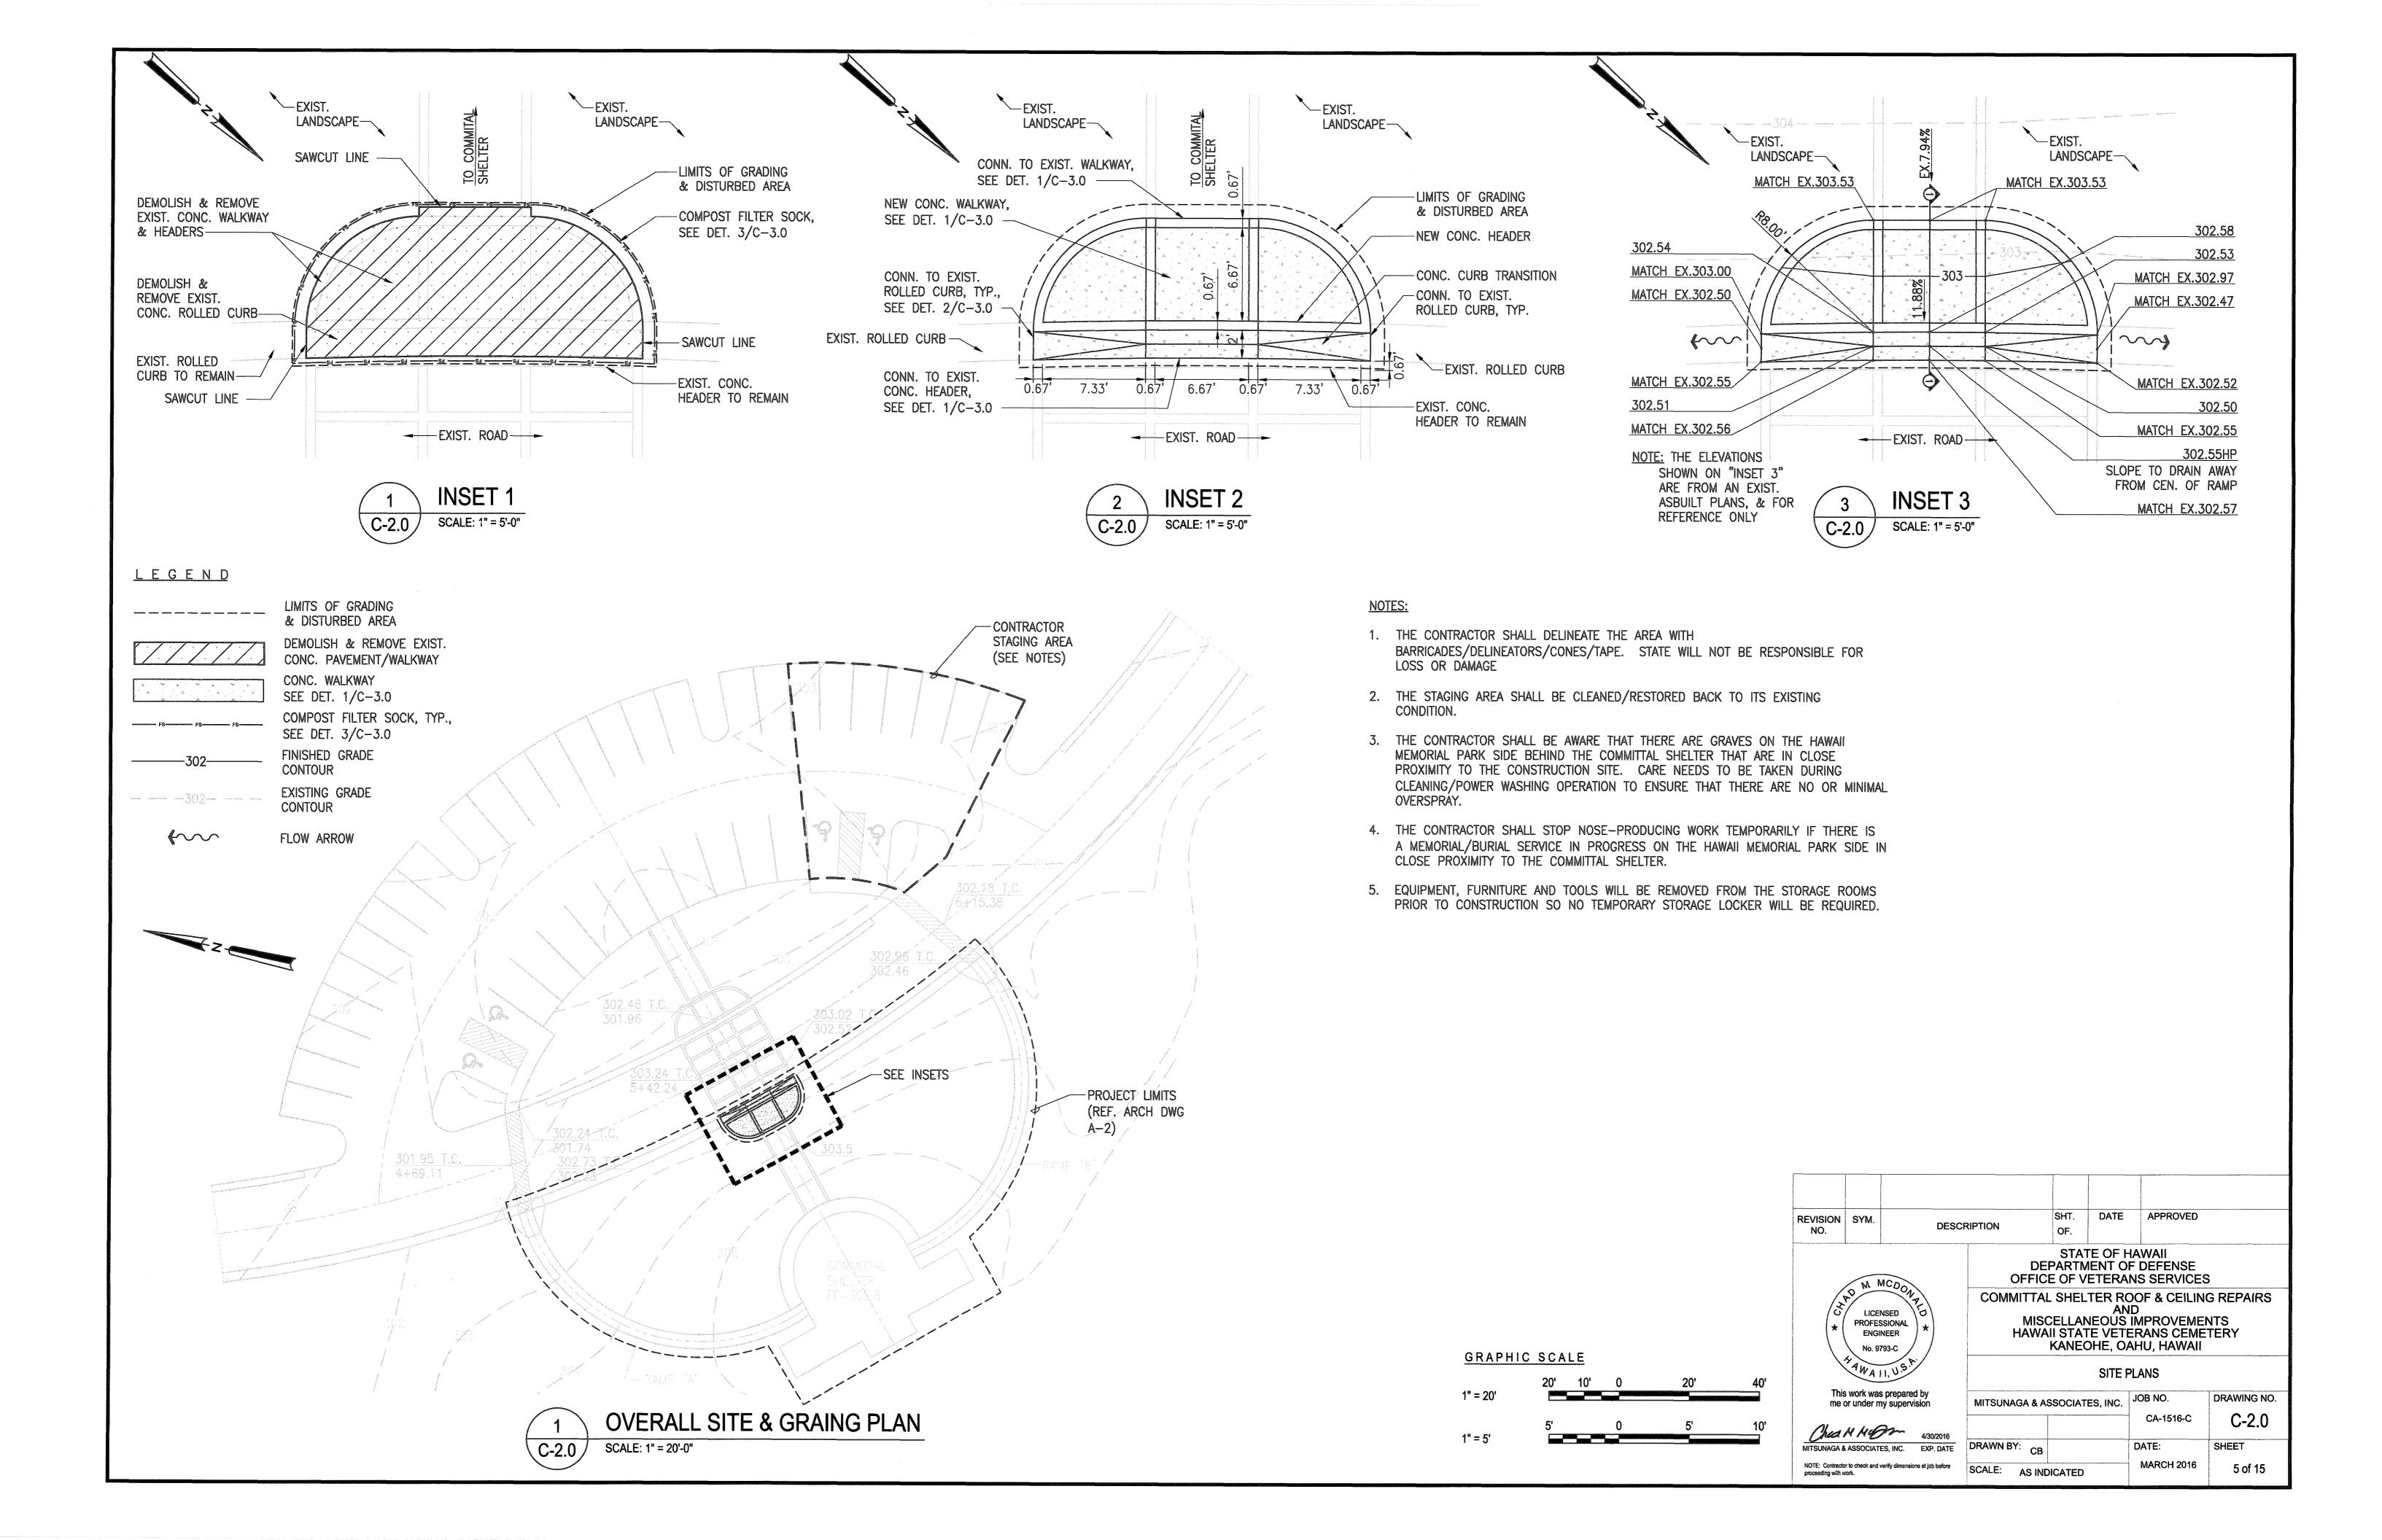

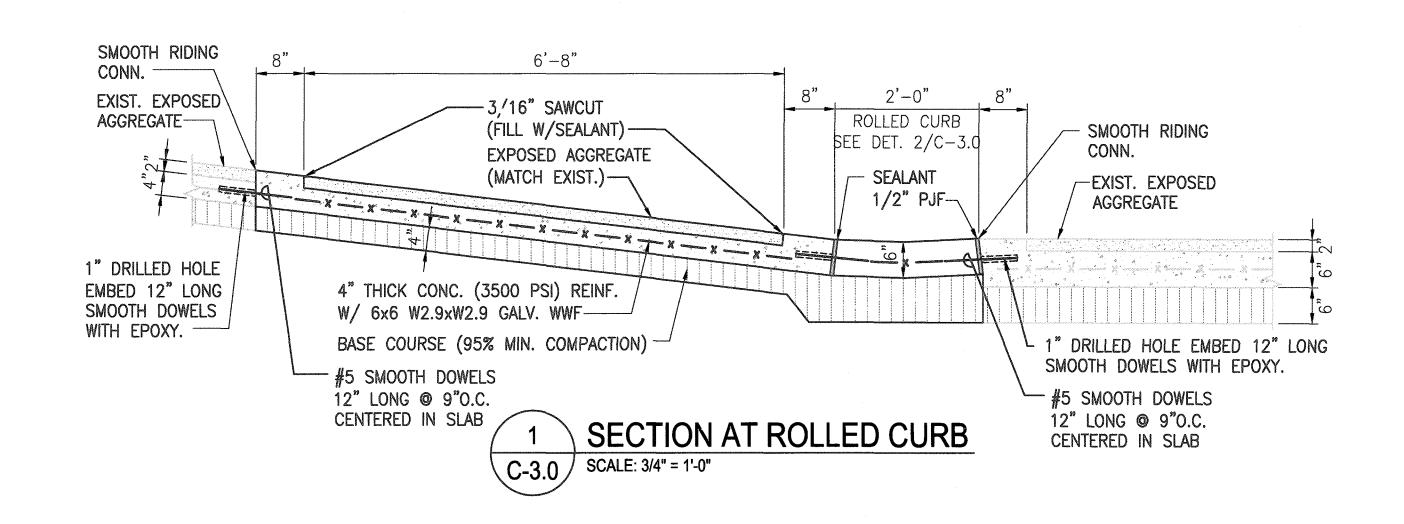


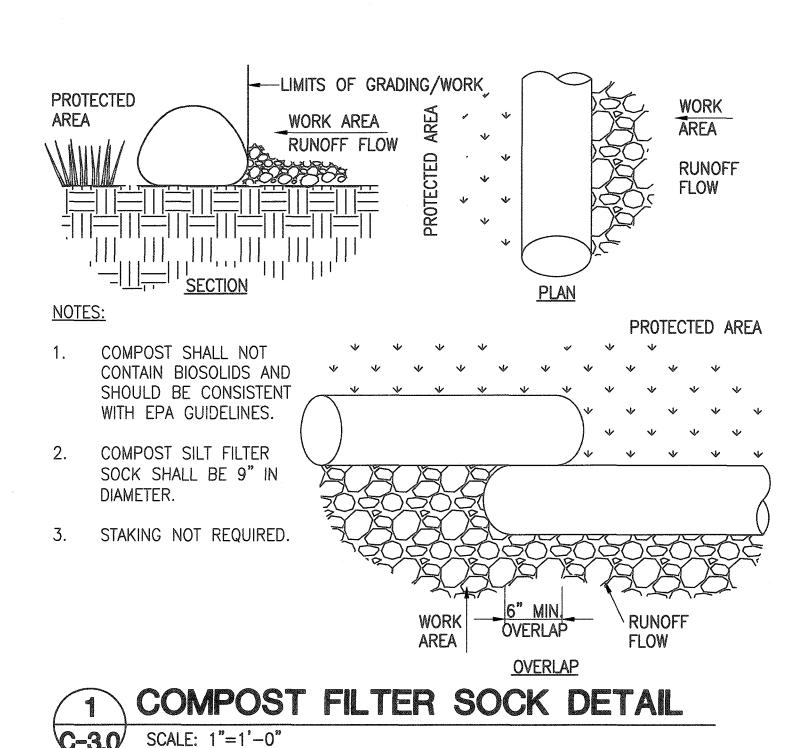


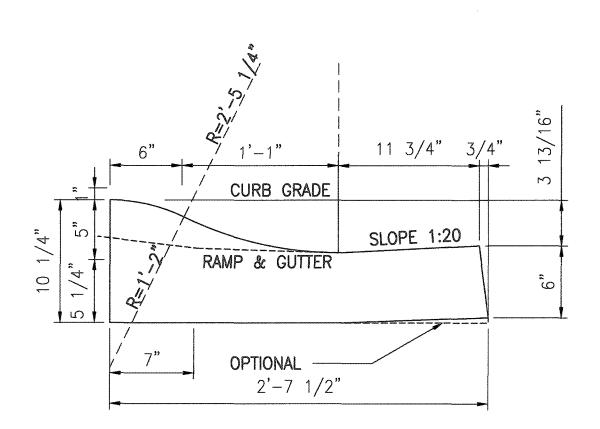


2 CAST IN PLACE ROLLED CURB SECTION

SCALE: 1-1/2""=1'-0"

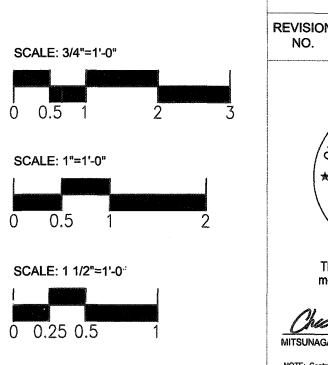


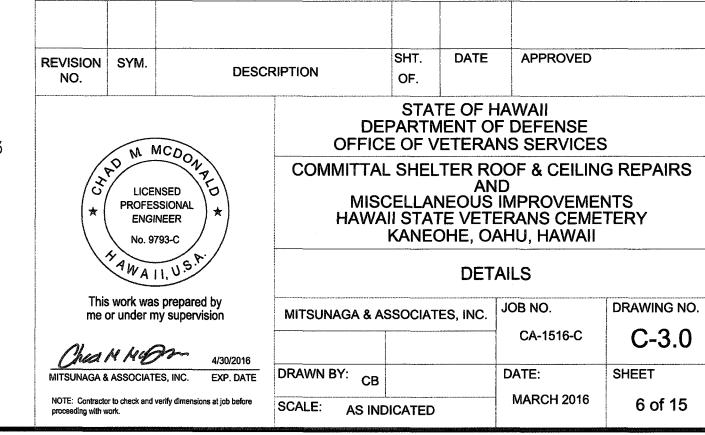


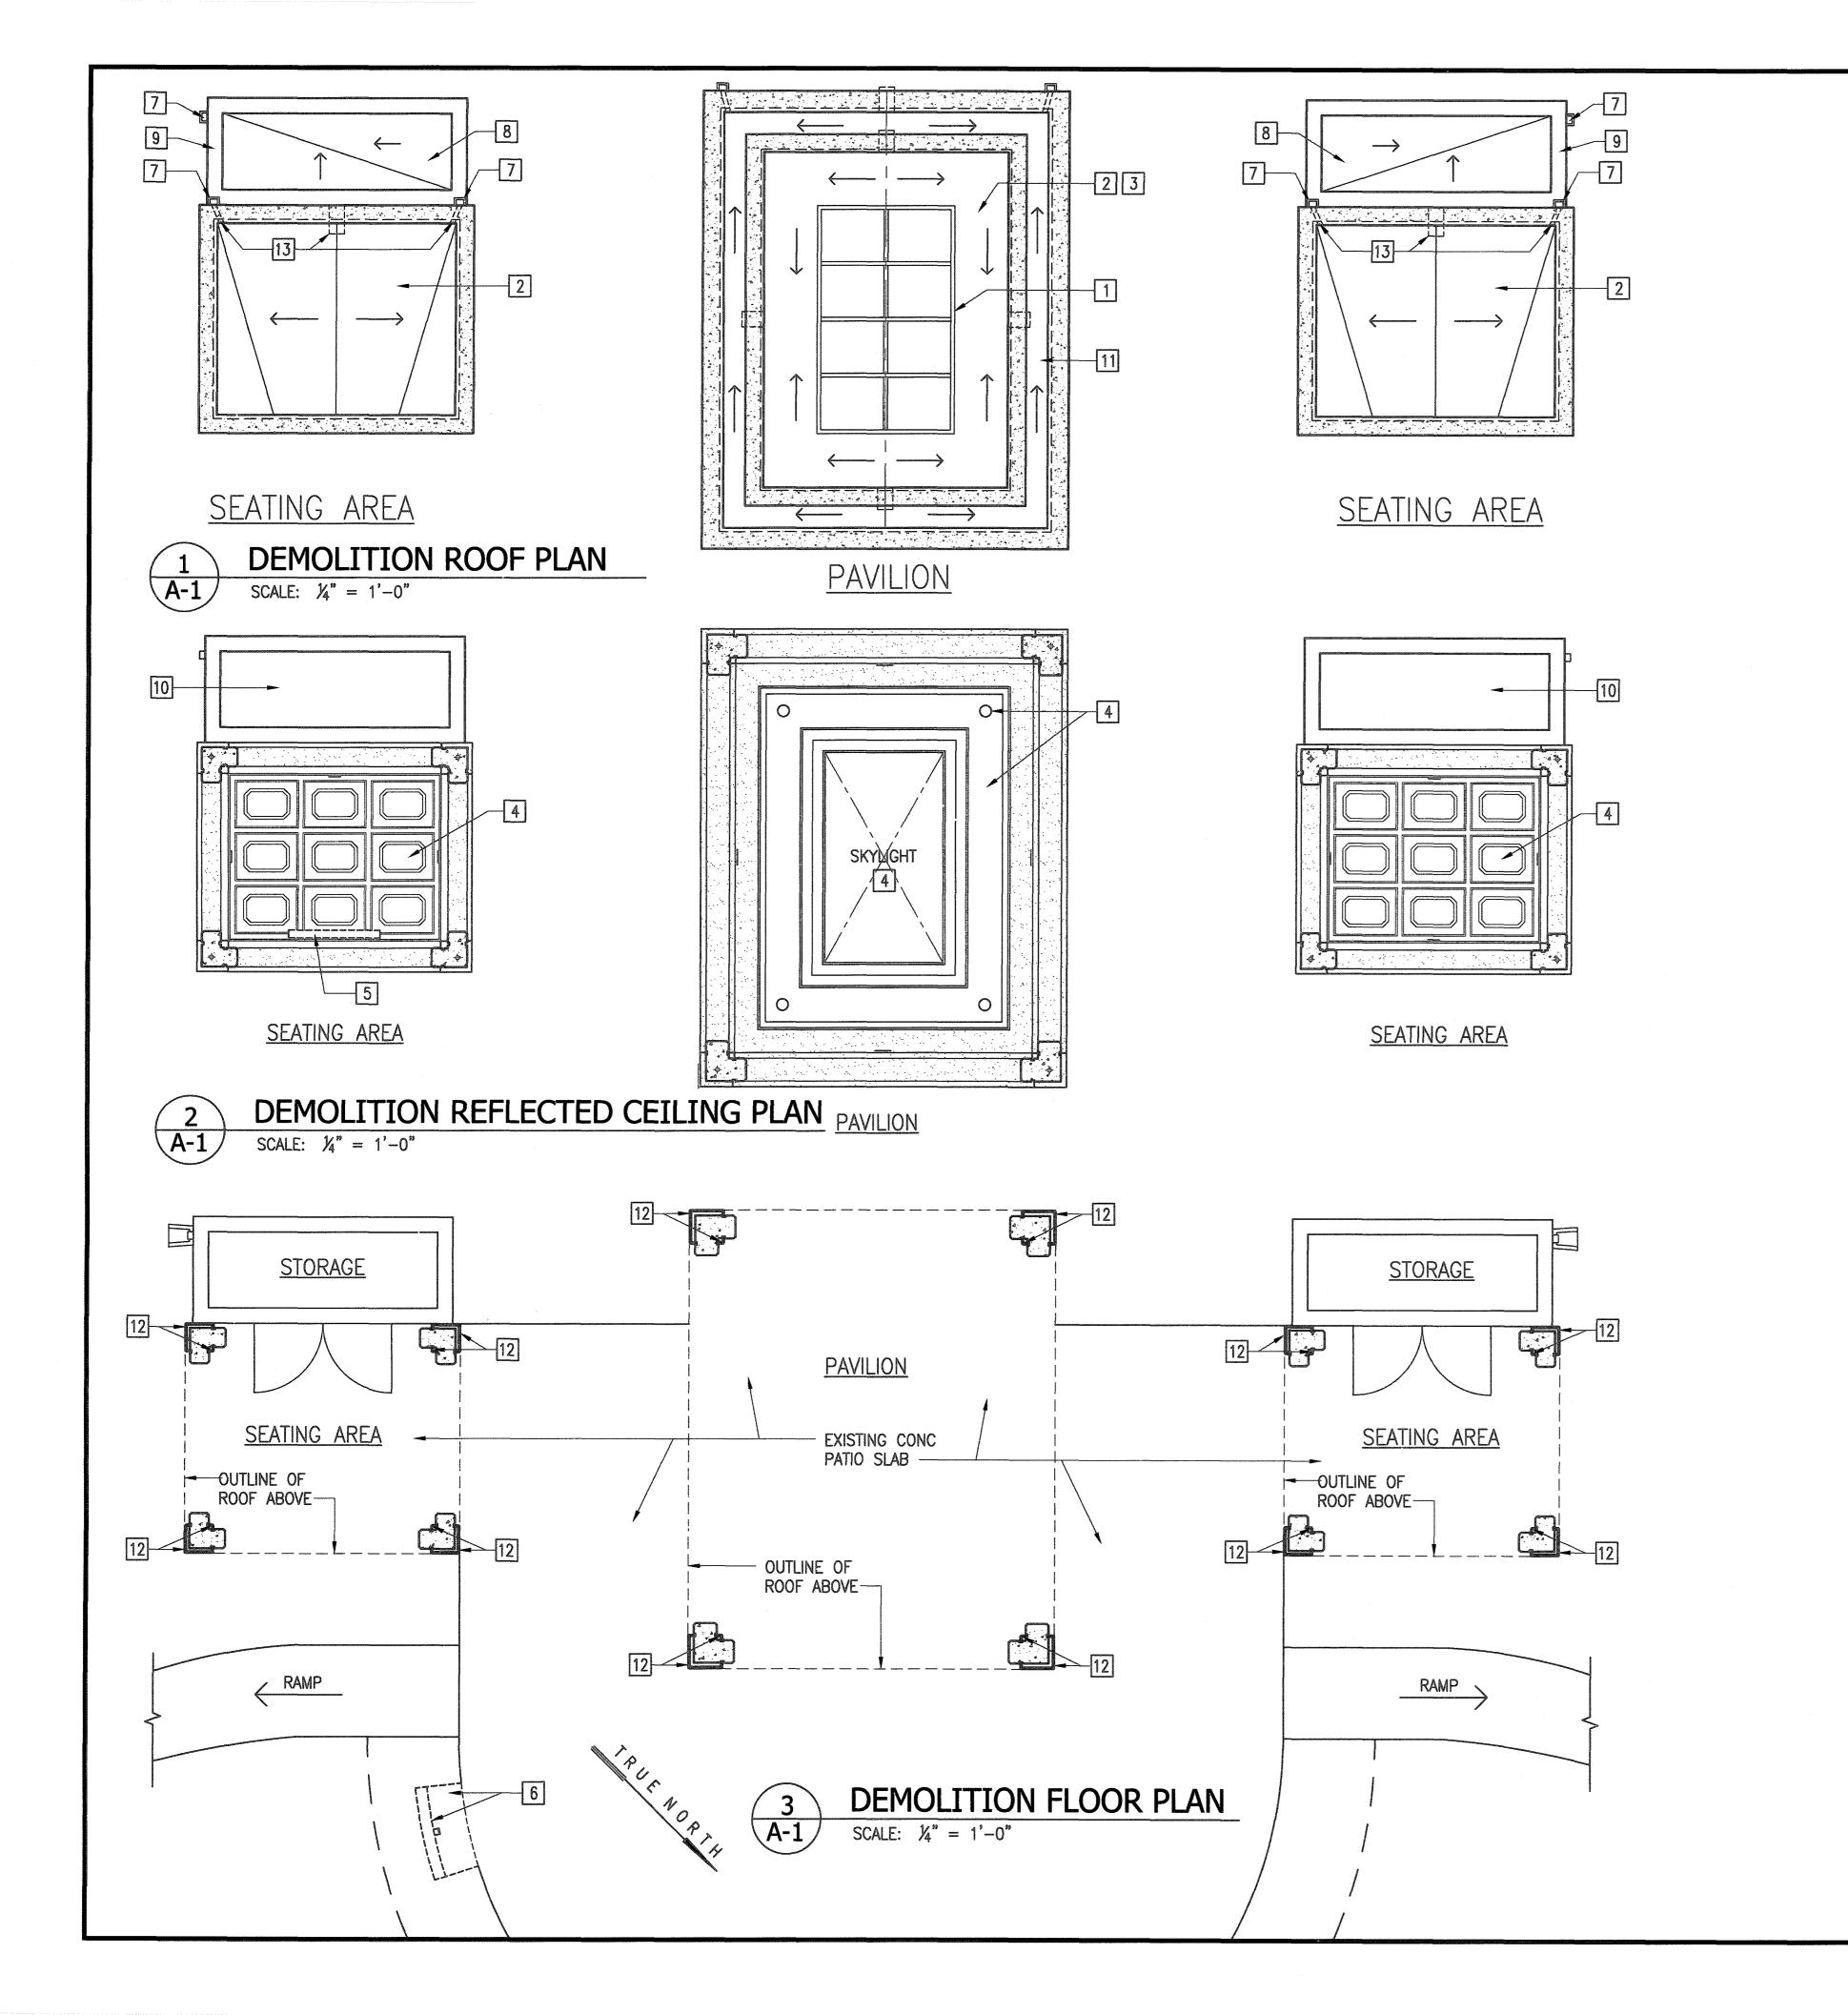



DEMOLITION KEY NOTES

- REMOVE EXISTING ALUMINUM FRAMED SKYLIGHT. RESEAL THE EXISTING GLAZING AND REPLACE OR REPAIR THE INTEGRAL CAP FLASHING AS NECESSARY TO ENSURE A WATERTIGHT ASSEMBLY. THE SKYLIGHT SHALL BE STORED SAFELY UNTIL IT IS READY TO BE REINSTALLED.
- 2 COMPLETELY REMOVE EXISTING ROOF ASSEMBLY, INCLUDING BUT NOT LIMITED TO: ROOFING MEMBRANE, METAL FLASHING, RECOVER BOARDS, RIGID INSULATION, WOOD NAILERS, CANT STRIPS, GYP BOARD SHEATHING AND PLYWOOD DECKING.
- 3 COMPLETELY REMOVE EXISTING WOODEN ROOF FRAMING, INCLUDING BUT NOT LIMITED TO: STRUCTURAL FRAMING MEMBERS, ANCHOR BOLTS, CONNECTION PLATES AND JOIST HANGERS.
- 4 COMPLETELY REMOVE EXISTING CEILING ASSEMBLY, INCLUDING BUT NOT LIMITED TO: RECESSED LIGHT FIXTURES, HDWD PLYWOOD SHEATHING, FURRING STRIPS, WOOD TRIMS AND MOULDING.
- 5 REMOVE WALL MOUNTED LIGHT FIXTURE
- 6 REMOVE CONCRETE DRINKING FOUNTAIN SUPPORT WALL AND SLAB ON GRADE, INCLUDING WATER PIPING AND DRAIN LINE. CAP WATER AND DRAIN LINES 6" BELOW GRADE, MIN. AFTER REMOVAL, LANDSCAPE VOID TO MATCH EXISTING SHRUBBERY.
- 7 EXISTING COPPER LEADER BOX AND DOWNSPOUT TO REMAIN,
- 8 ROOFING SYSTEM ABOVE EXISTING STORAGE ROOM TO REMAIN.
- 9 EXISTING COPPER FLASHING TO REMAIN.
- 10 STORAGE ROOM CEILING TO REMAIN.
- 11 REMOVE EXISTING METAL PAN
- 12 REMOVE EXISTING TRAVERTINE PANELS AT BOTTOM COURSE
- 13 REMOVE EXISTING METAL SCUPPERS.

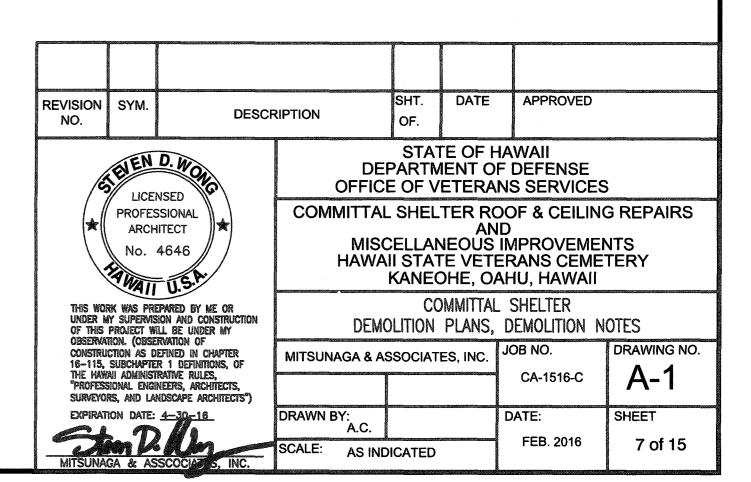

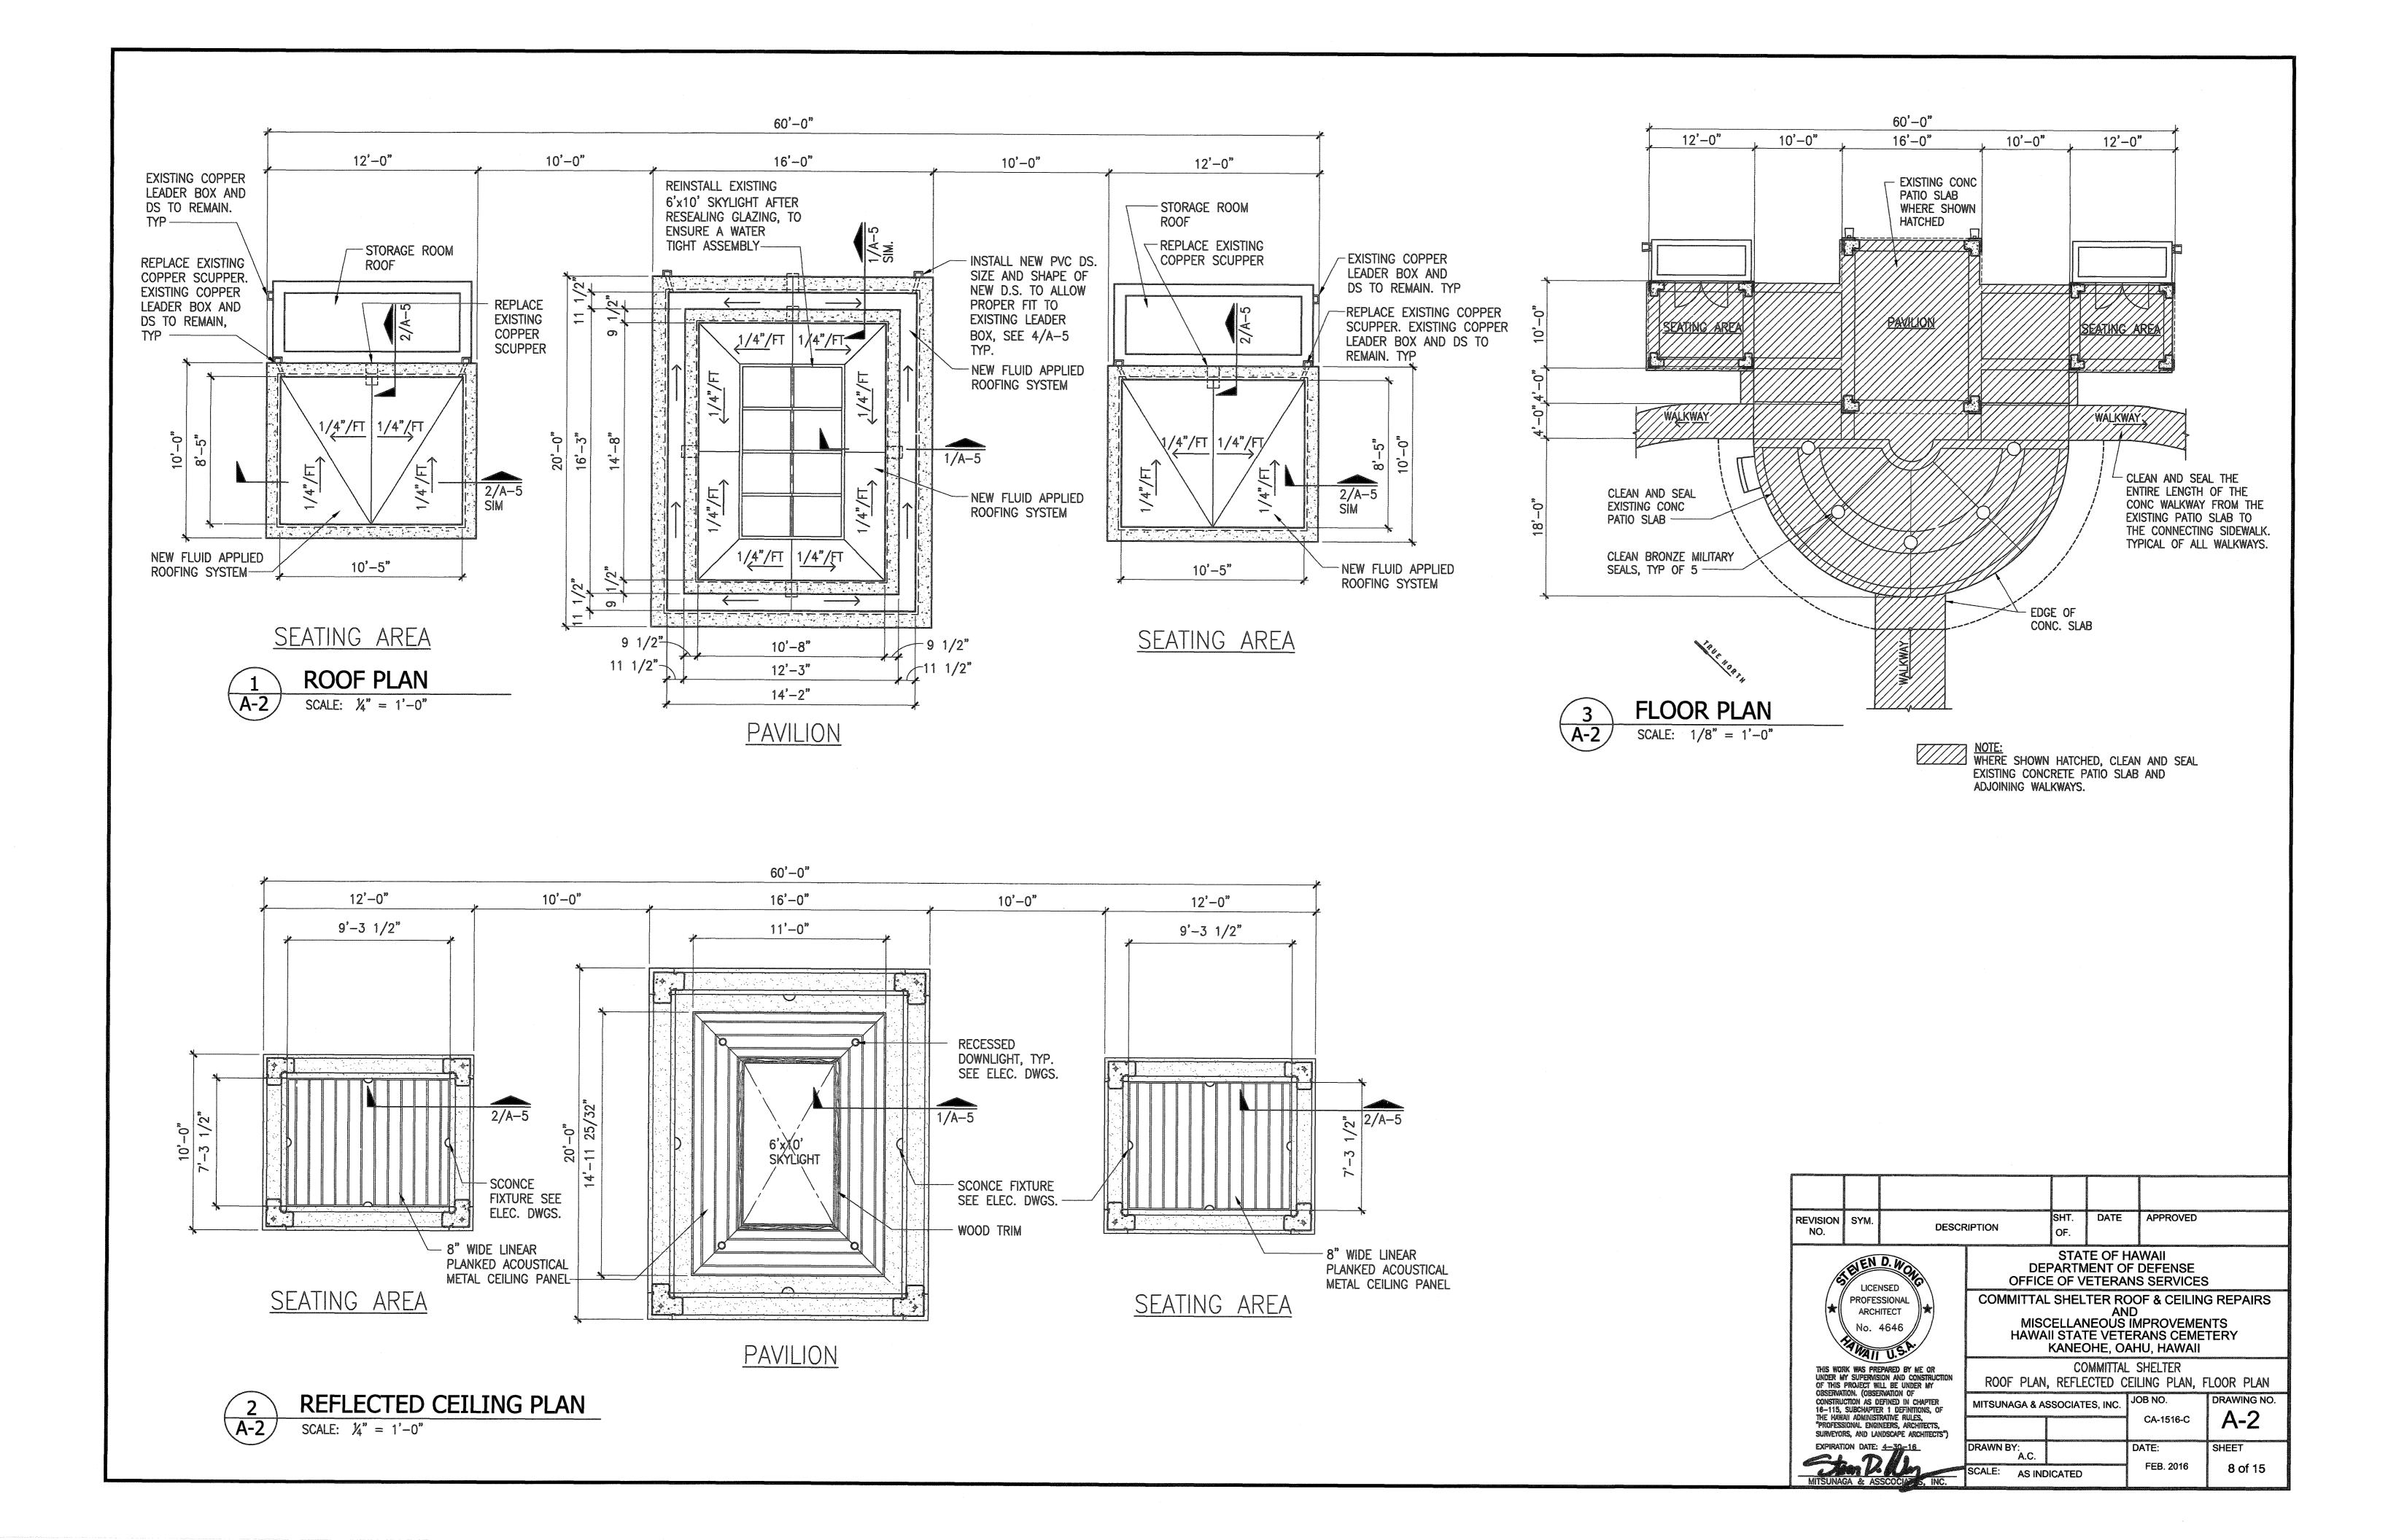

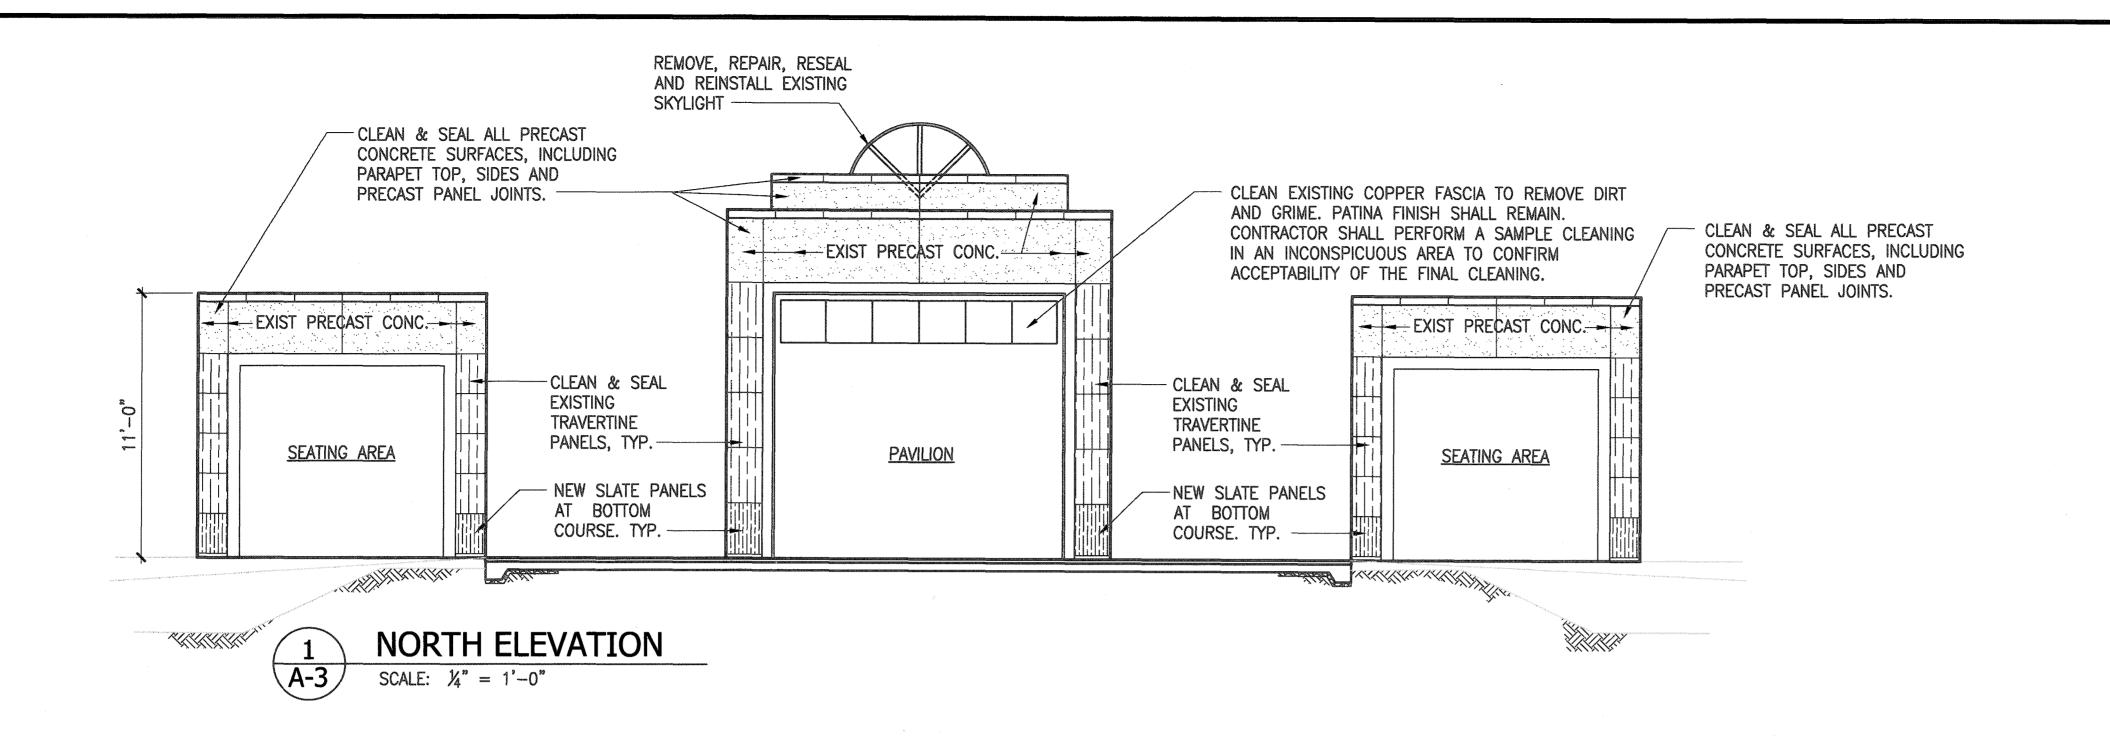

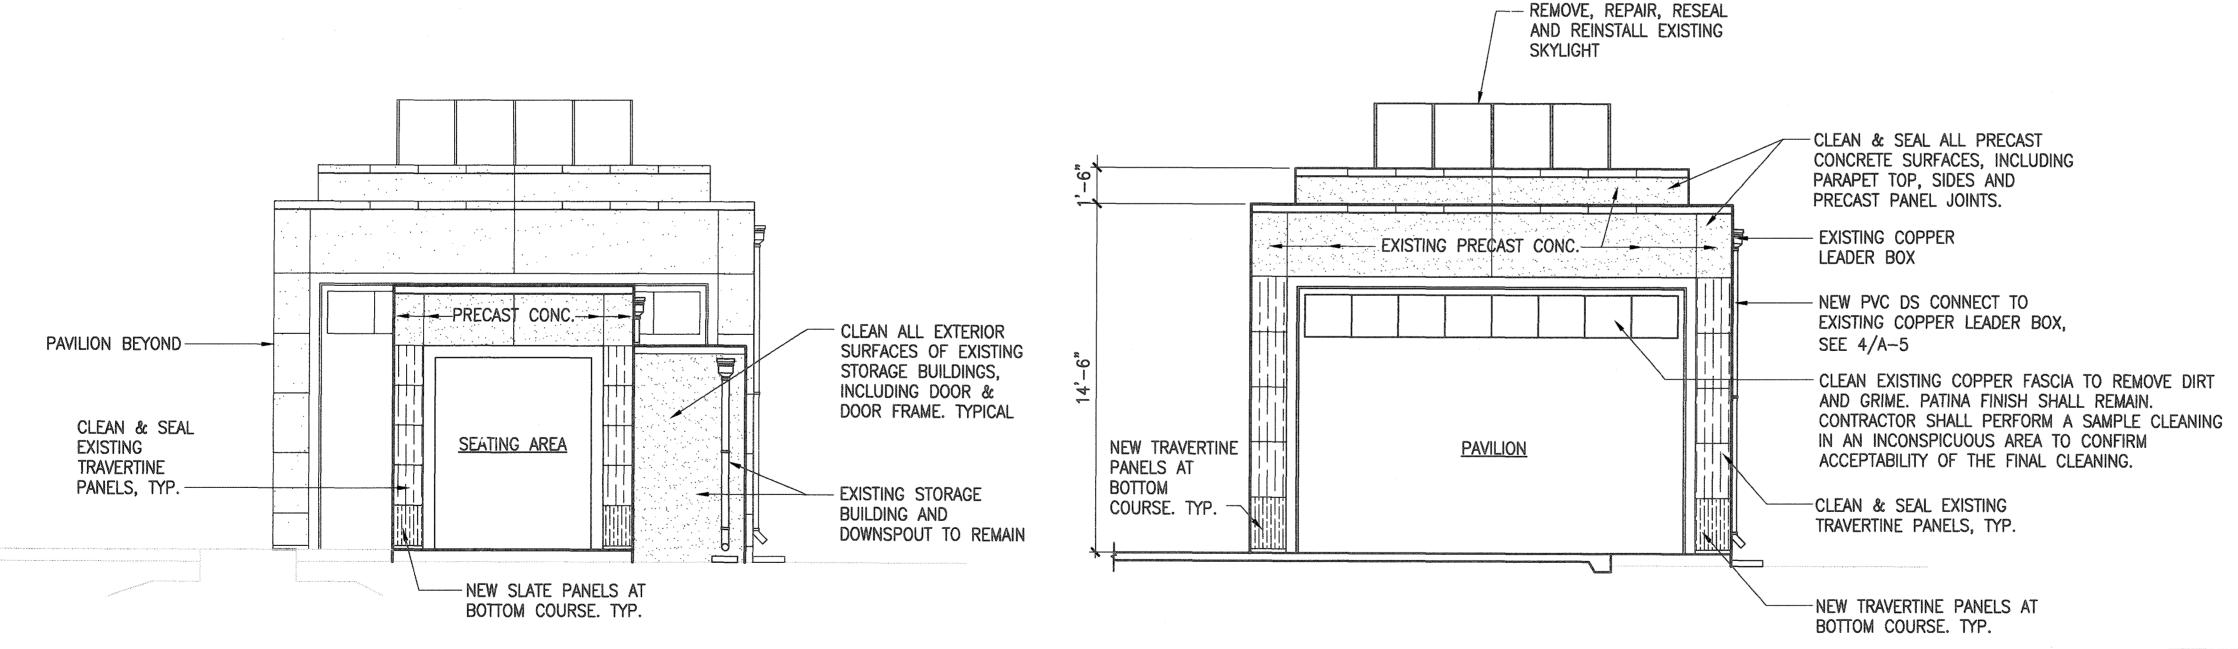



2 EAST ELEVATION (WEST SAME, REVERESED)


SCALE: ¼" = 1'-0"


EAST ELEVATION OF PAVILION (WEST SAME, REVERESED)

SCALE: 1/4" = 1'-0"

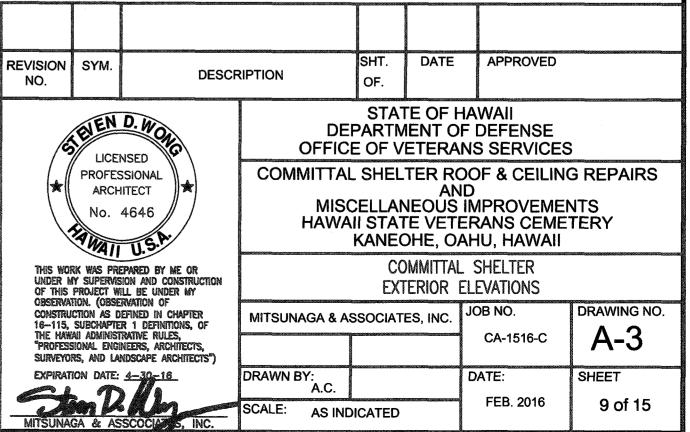

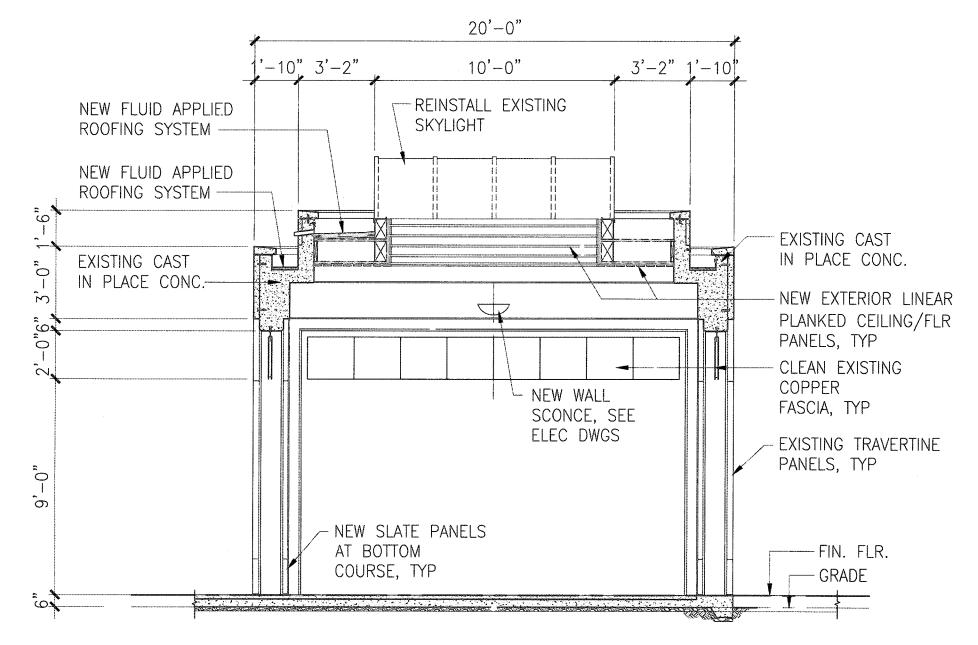

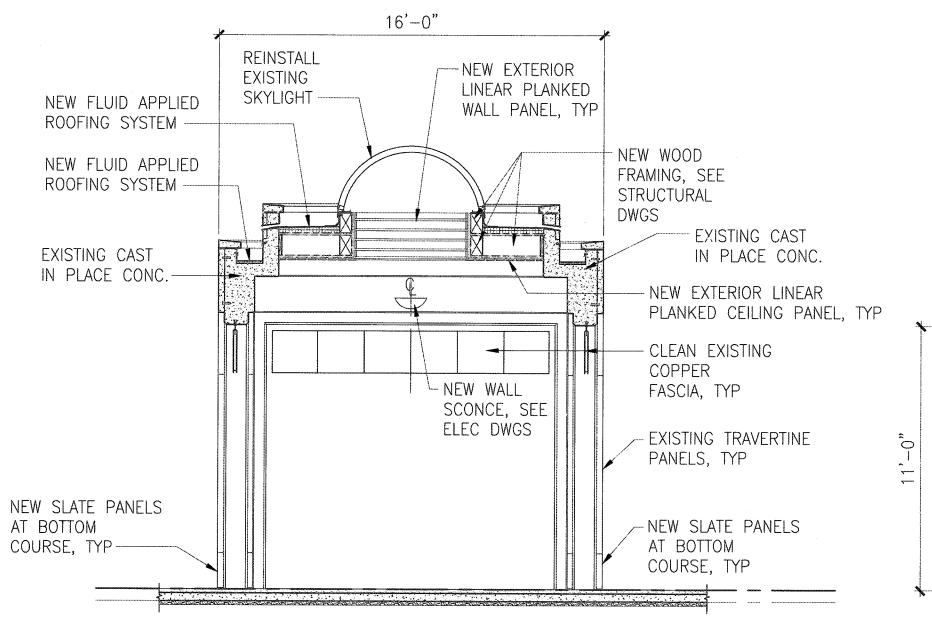


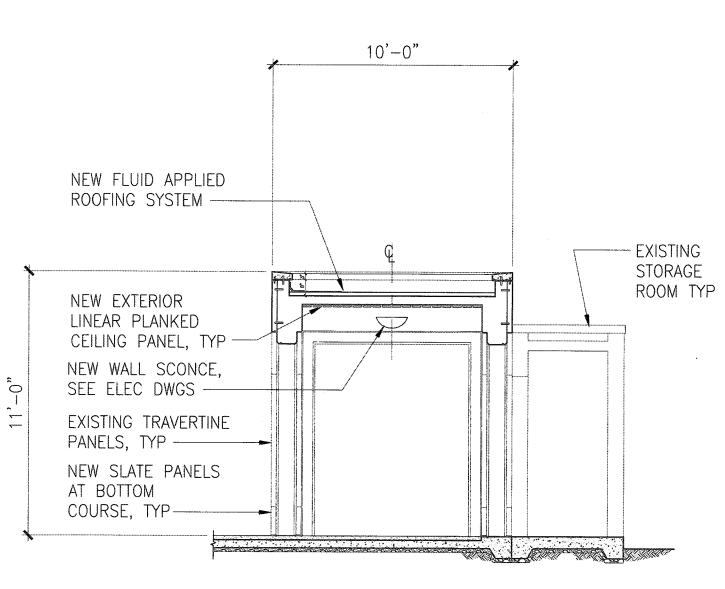



PAVILION LONGITUDINAL SECTION

PAVILION CROSS SECTION

SEATING AREA CROSS SECTION

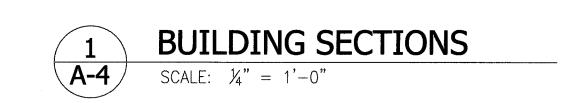

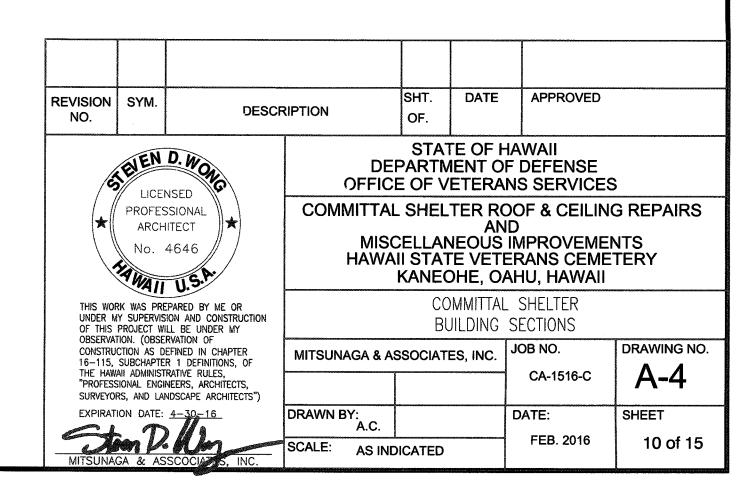

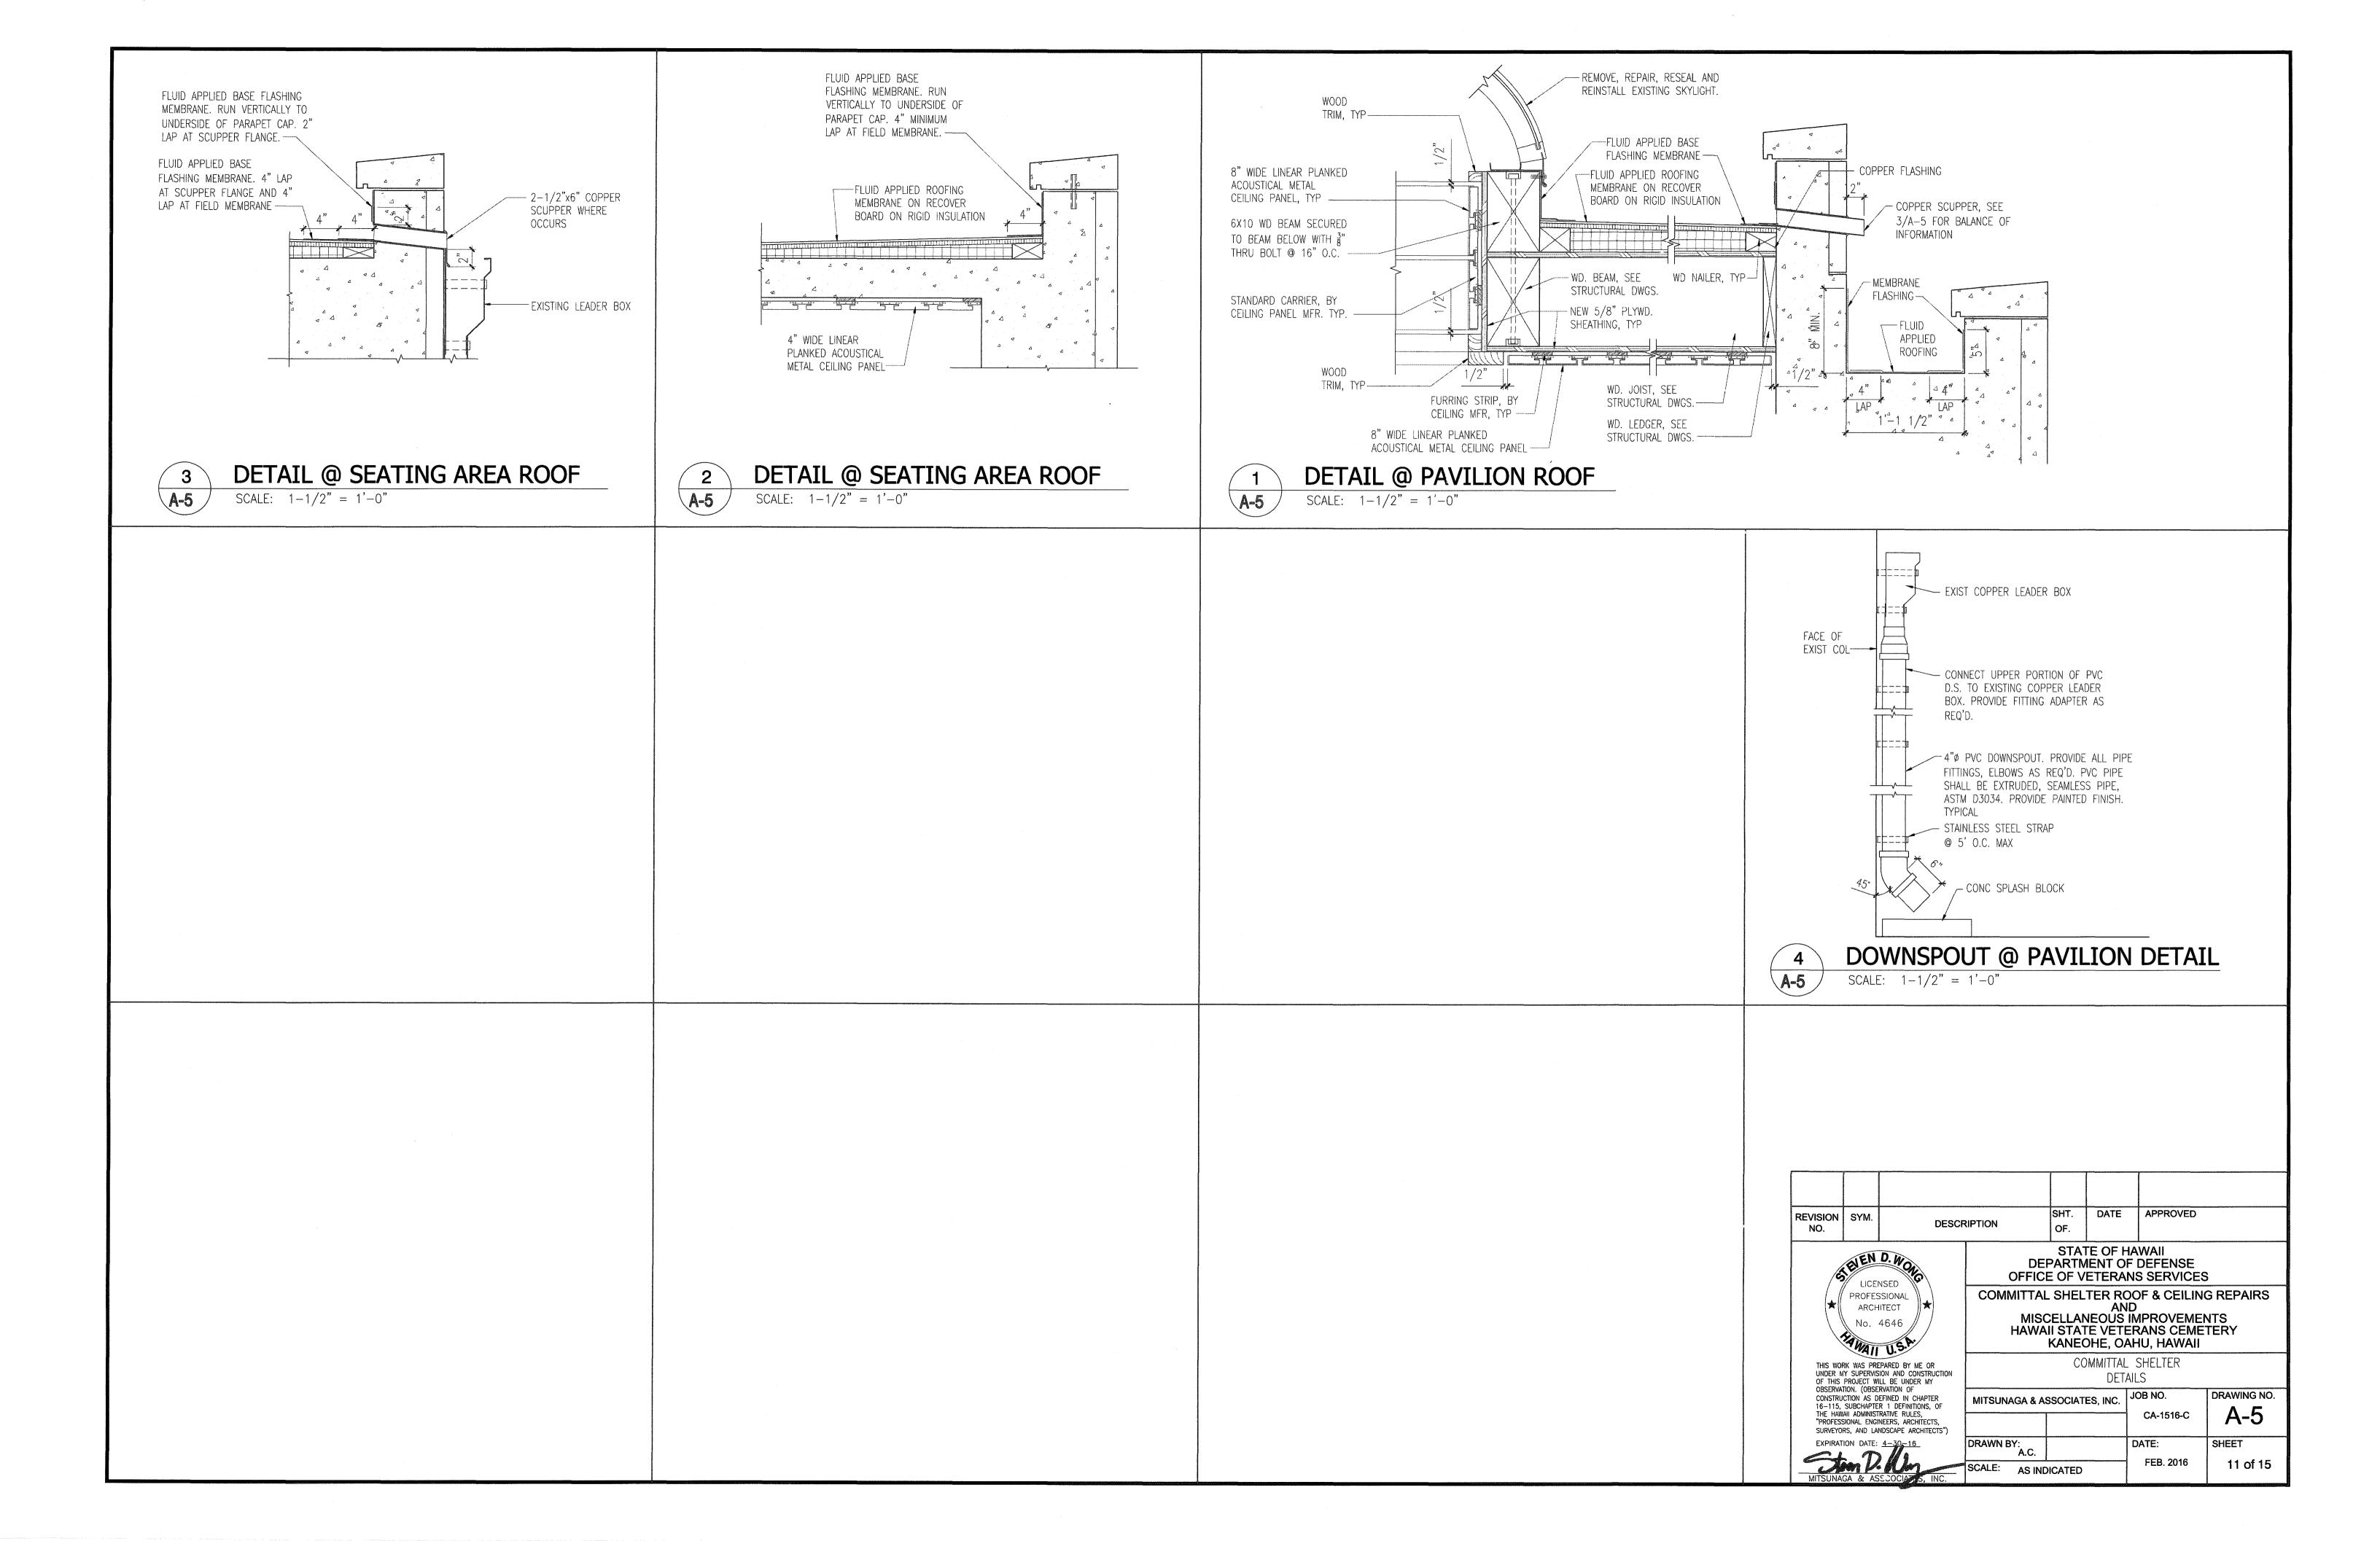

GENERAL NOTES

<u>GENERAL</u>

- 1. ALL MATERIALS AND WORKMANSHIP SHALL CONFORM TO THE DRAWINGS AND THE SPECIFICATIONS, AND SHALL CONFORM TO THE INTERNATIONAL BUILDING CODE 2006 EDITION, AS ADOPTED BY THE CITY AND COUNTY OF HONOLULU.
- 2. THE CONTRACTOR SHALL BE RESPONSIBLE FOR COORDINATING THE WORK OF ALL TRADES AND SHALL VERIFY ALL DIMENSIONS AND CONDITIONS PRIOR TO STARTING WORK. ALL DISCREPANCIES, OMISSIONS OR CONFLICTS SHALL BE REPORTED TO THE CONTRACTING OFFICER AND BE RESOLVED BEFORE BIDDING.
- 3. ALL INFORMATION SHOWN ON THE DRAWINGS RELATIVE TO EXISTING CONDITIONS IS GIVEN AS THE BEST PRESENT KNOWLEDGE, BUT WITHOUT GUARANTEE OF ACCURACY. WHERE ACTUAL CONDITIONS CONFLICT WITH THE DRAWINGS, THEY SHALL BE REPORTED TO THE CONTRACTING OFFICER SO THAT THE PROPER REVISIONS MAY BE MADE.
- 4. SHOP DRAWINGS REQUIRED BY THE SPECIFICATIONS SHALL BE SUBMITTED TO THE CONTRACTING OFFICER FOR REVIEW PRIOR TO FABRICATION.
- 5. DURING CONSTRUCTION, THE CONTRACTOR SHALL BE RESPONSIBLE FOR THE SAFETY OF THE JOBSITE. THE CONTRACTOR SHALL PROVIDE ADEQUATE SHORING, BRACING, GUYS, ETC., IN ACCORDANCE WITH ALL SAFETY ORDINANCES.


DESIGN LOADS

ED B JEDS B		
1.	LIVE LOAD a. ROOF: b. FLOOR SLAB ON GRADE:	20 PSF 150 PSF
2.	LATERAL LOAD a. SEISMIC IMPORTANT FACTOR: Ss: S1: SITE CLASS: SDS: SD1: SEISMIC DESIGN CATEGORY: SEISMIC FORCE RESISTING SYSTEM: RESPONSE MODIFICATION COEF.: b. WIND BACIS WIND SPEED: IMPORTANT FACTOR: EXPOSURE: BUILDING ENCLOSURE CLASS: TOPOGRAPHIC FACTOR:	1.0 0.613 0.177 D 0.535 0.247 D MOMENT RESISTING SYSTEMS 3.0 130 MPH 1.0 B OPEN 1.6


STRUCTURAL TIMBER

- 1. ALL LUMBER SHALL BE DOUGLAS FIR-LARCH, NO. 2 GRADE OR GREATER FOR BEAMS, AND NO. 2 GRADE OR GREATER FOR 2" TO 4" THICK AND WIDER SIZES.
- AND NO. 2 GRADE OR GREATER FOR 2" TO 4" THICK AND WIDER SIZES.

 2. ALL LUMBER SHALL BE TREATED IN ACCORDANCE WITH THE SPECIFICATIONS FOR TERMITE AND FIRE RESISTANCE.
- 3. ALL TIMBER CONNECTIONS SHALL BE GALVANIZED AND IN ACCORDANCE WITH THE SIZES AND SHAPES SHOWN OR AS APPROVED EQUAL BY THE ENGINEER.
- 4. EXPANSION ANCHOR BOLTS SHALL BE HILTI KWIK BOLTS OR APPROVED EQUAL.

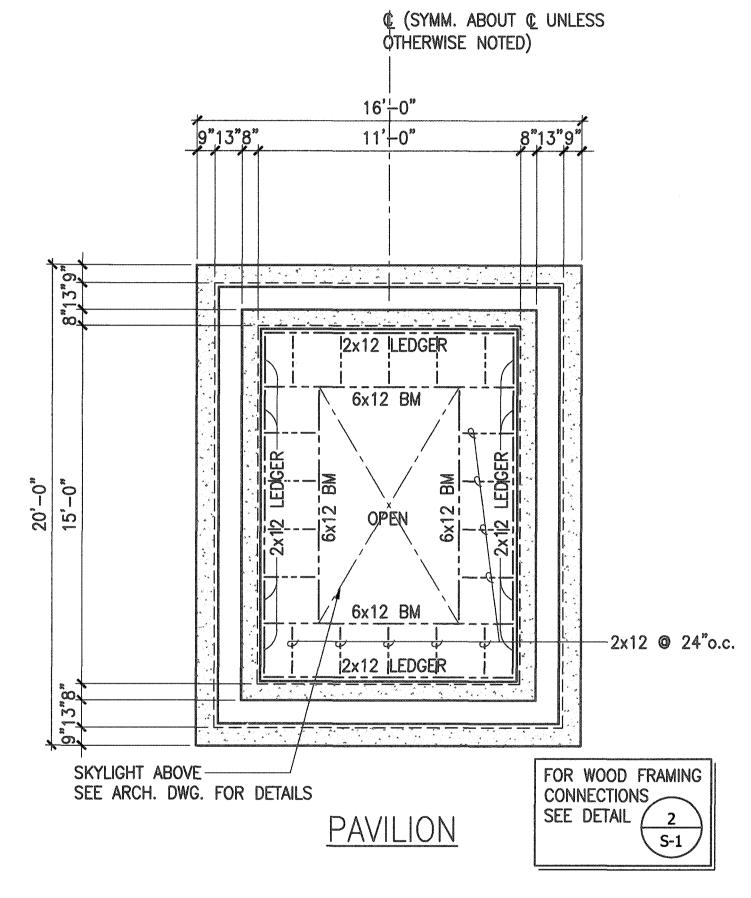



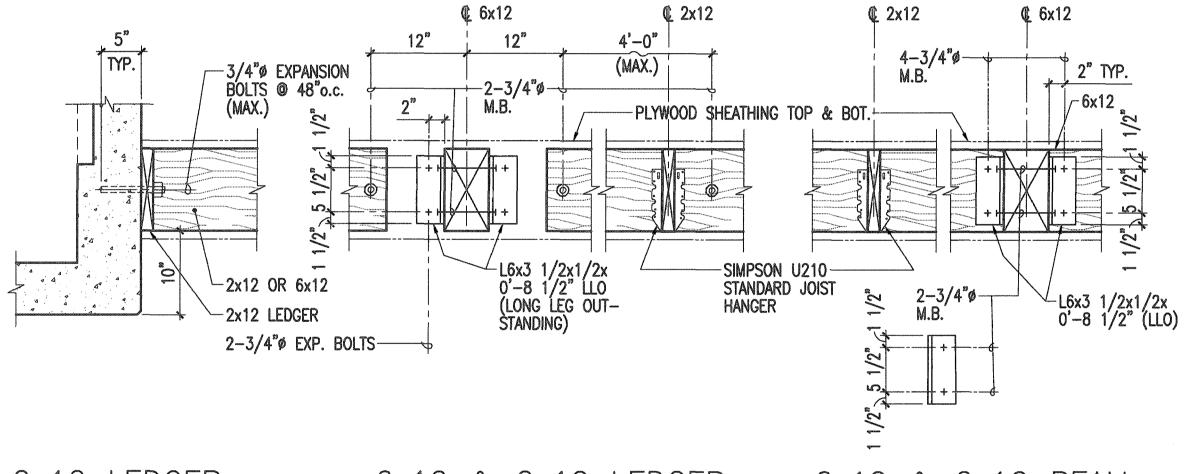

2x12 LEDGER ANCHORAGE DET. 6x12 & 2x12 LEDGER


6x12 & 2x12 BEAM



ROOF WOOD FRAMING CONNECTION DETAILS

NOT TO SCALE


REVISION NO.	SYM.	DESCF	SHT. OF.	DATE	APPROVED				
	LICENSED POPESSIONAL ENGINEER No. 2422-S A WAII, U.S. P.			STATE OF HAWAII DEPARTMENT OF DEFENSE OFFICE OF VETERANS SERVICES					
\\\ *				COMMITTAL SHELTER ROOF & CEILING REPAIRS AND MISCELLANEOUS IMPROVEMENTS HAWAII STATE VETERANS CEMETERY KANEOHE, OAHU, HAWAII					
THIS WORK WAS PREPARED BY ME OR UNDER MY SUPERVISION AND CONSTRUCTION OF THIS PROJECT WILL BE UNDER MY			GENERAL NOTES, ROOF FRAMING PLAN, ROOF WOOD FRAMING CONNECTION DETAILS						
OBSERVATION. (OBSERVATION OF CONSTRUCTION AS DEFINED IN CHAPTER 16—115, SUBCHAPTER 1 DEFINITIONS, OF		MITSUNAGA & ASSOCIATES, INC.			JOB NO.	DRAWING NO.			
THE HAM PROFES	ai administ Sional Engi	RATIVE RULES, OF RATIVE RULES, NEERS, ARCHITECTS, NDSCAPE ARCHITECTS")				CA-1516-C	S-1		
Ilm		4-30-16 SCOCIATES, INC.	DRAWN BY: A.U. SCALE: AS IN	DICATED		DATE: FEB. 2016	12 of 15		

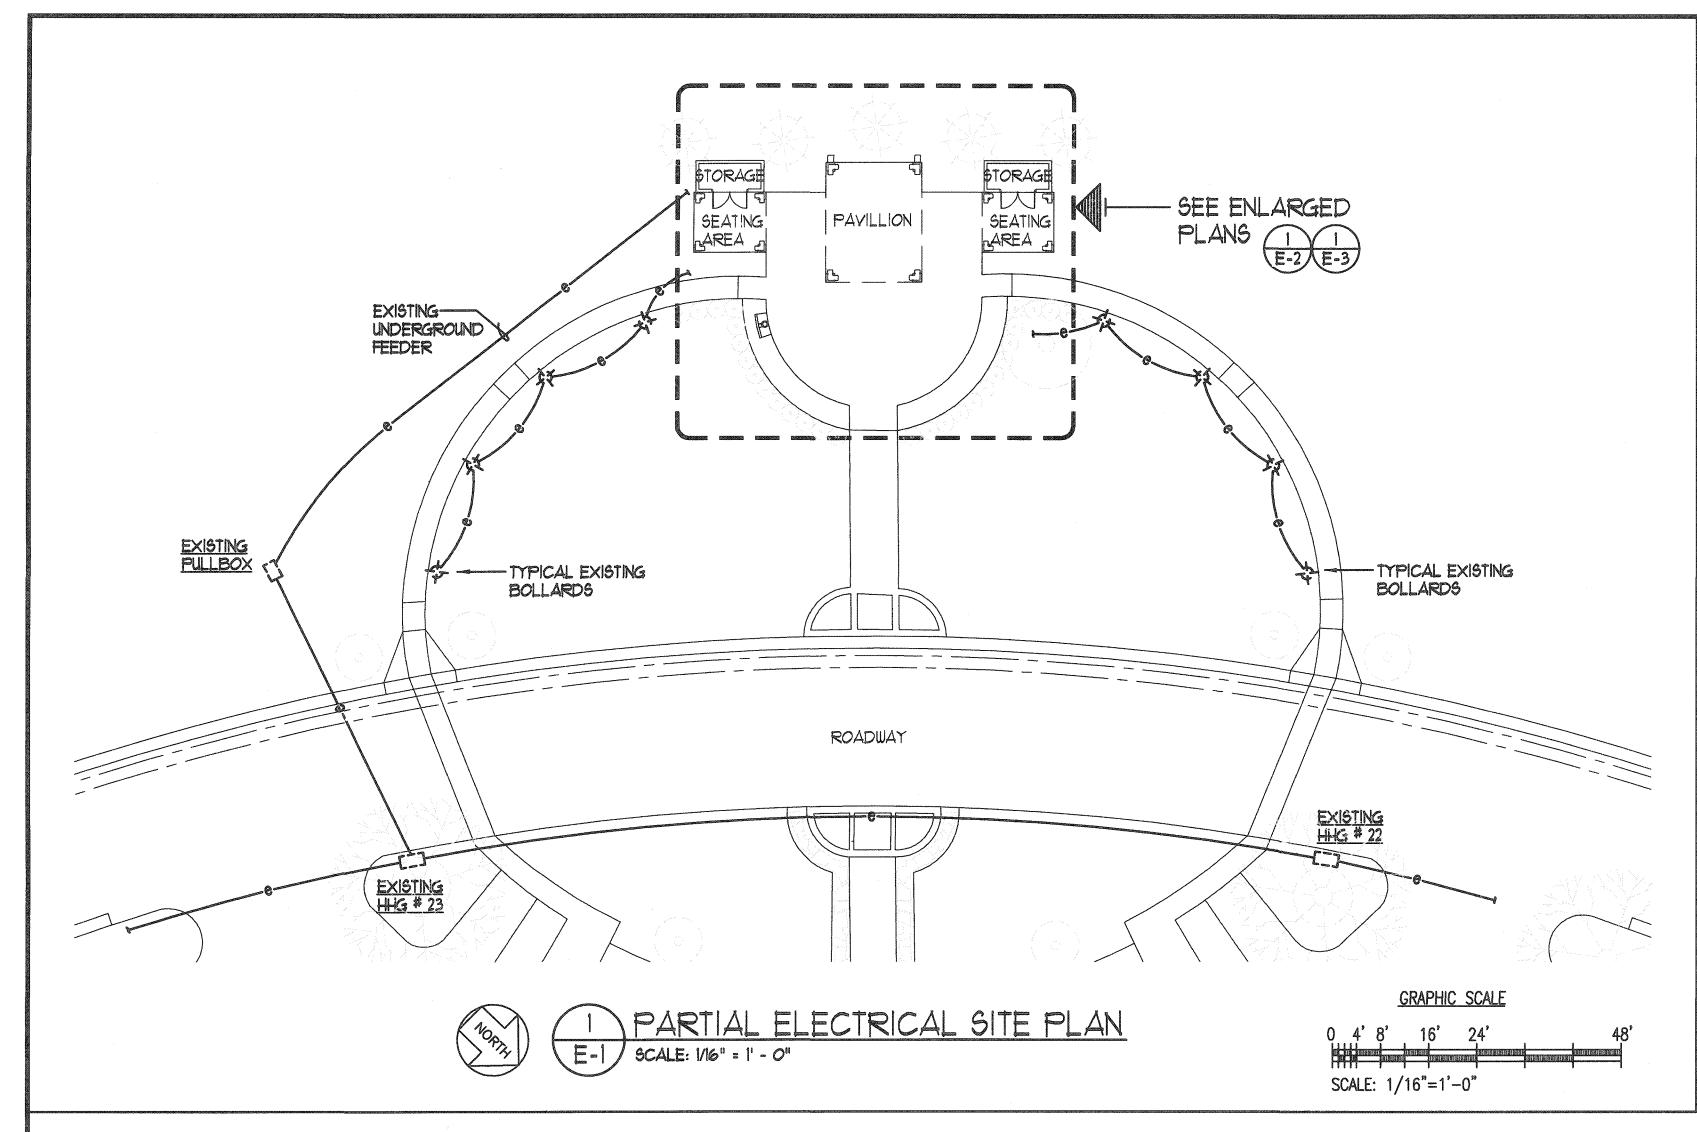

GENERAL ELECTRICAL NOTES:


- ELECTRICAL CONTRACTOR SHALL VISIT THE JOB SITE AND FAMILIARIZE HIMSELF WITH ALL EXISTING CONDITIONS PRIOR TO BIDDING. BID SUBMISSION SHALL BE CONSIDERED AS CONFIRMATION THAT THE CONTRACTOR HAS VISITED THE SITE AND HAS RESOLVED ALL DISCREPANCIES AND QUESTIONS REGARDING THE WORK. NO EXTRA PAYMENT WILL BE GIVEN FOR WORK MADE NECESSARY BY THE CONTRACTOR'S FAILURE TO VISIT THE SITE.
- 2. ALL RACEWAYS AND OUTLETS SHALL BE CONCEALED UNLESS OTHERWISE NOTED.
- 3. CONDUIT SIZES INDICATED ON THE DRAWINGS ARE NOT NECESSARILY BASED ON THE MINIMUM SIZE ALLOWED BY THE NATIONAL ELECTRICAL CODE AND MAY BE PURPOSELY OVERSIZED FOR FUTURE CONDUCTORS OR TO AVOID CONDUIT HEATING. CONDUIT SIZES NOT CALLED OUT ON THE DRAWINGS SHALL BE SIZED BY THE CONTRACTOR, BASED ON THE ACTUAL NUMBER OF CONDUCTORS TO BE INSTALLED, USING THE NATIONAL ELECTRICAL CODE AS A GUIDE. IN NO CASE SHALL CONDUIT SIZES BE SMALLER THAN 3/4" DIAMETER.
- 4. ALL WIRING SHALL INCLUDE AN INSULATED GREEN GROUNDING CONDUCTOR SIZED PER TABLE 250-95 OF THE NATIONAL ELECTRICAL CODE. THIS CONDUCTOR SHALL BE CARRIED IN ALL RACEWAYS INCLUDING THOSE INSTALLED FOR SWITCH LEGS AND SHALL BE ATTACHED TO THE DEVICE, LIGHT FIXTURE, OR EQUIPMENT HOUSING USING A SUITABLE GROUNDING LUG.
- 5. THE CONTRACTOR SHALL PROVIDE AND INSTALL ALL JUNCTION AND PULL BOXES REQUIRED FOR THE INSTALLATION OF ELECTRICAL DEVICES AND EQUIPMENT, WHETHER OR NOT SPECIFICALLY INDICATED ON THE PLANS. SIZING OF THESE BOXES SHALL BE PER THE NATIONAL ELECTRICAL CODE.
- 6. THE CONTRACTOR SHALL CONFIRM THE TYPE OF CEILING BEING INSTALLED PRIOR TO ORDERING RECESSED LIGHTING FIXTURES. CATALOG NUMBERS MAY NOT INDICATE THE TYPE OF CEILING BEING PROVIDED BY OTHER TRADES. NON CONFIRMING OF CEILING AND IMPROPER ORDERING OF LIGHTING FIXTURES SHALL NOT BE CONSIDERED REASON FOR EXTRA COST.
- PROJECT CONDITIONS MAY REQUIRE REARRANGEMENT OF ELECTRICAL WORK, THE CONTRACTOR SHALL INDICATE SUCH CHANGES ON THE AS-BUILT DRAWINGS. WHERE CHANGES REQUIRE ALTERNATE METHODS TO THOSE SPECIFIED IN THE CONTRACT DOCUMENTS, THE CONTRACTOR SHALL SUBMIT DRAWINGS SHOWING THE PROPOSED METHOD FOR APPROVAL. THE CONTRACTOR SHALL NOT PROCEED UNTIL APPROVAL IS OBTAINED. REARRANGEMENT OF WORK FOR THE PURPOSE OF COORDINATION BETWEEN TRADES SHALL NOT BE CONSIDERED A REASON FOR EXTRA COST.
- 8. EXISTING CONDITION SHOWN ON DRAWINGS ARE TAKEN FROM PAST DESIGN DRAWING AND MAY NOT REPRESENT ACTUAL FIELD CONDITIONS. PRIOR TO STARTING NEW WORK, CONTRACTOR SHALL VERIFY, TRACE, AND ALL EXISTING LIGHTING AND RECEPTACLES SHOWN. DEVIATIONS SHALL BE SHOWN ON AS-BUILT DRAWINGS.
- 9. THE CONTRACTOR SHALL COORDINATE HIS WORK WITH ALL OTHER TRADES.
- 10. THE CONTRACTOR SHALL LABEL EACH RECEPTACLE WITH PANEL NAME AND CIRCUIT NUMBER USE ADHESIVE LABELS - BLACK LETTERING ON CLEAR BACKGROUND.
- 11. THE CONTRACTOR SHALL RECONNECT ALL EXISTING AND CONNECT ALL NEW BRANCH CIRCUITS TO THE APPROPRIATE EXISTING ELECTRICAL PANEL.
- 12. THE CONTRACTOR SHALL FILL-IN THE PANEL SCHEDULES OF THE EXISTING ELECTRIC PANEL USING A TYPEWRITER. PROVIDE CIRCUIT DESCRIPTIONS BASED ON CIRCUIT TRACING OF EXISTING CIRCUITS AND PLAN DESCRIPTION FOR NEW CIRCUITS.

- 13. REFINISH AND PATCH TO MATCH ALL EXISTING WALL AND CEILING SURFACES DAMAGED OR SCRATCHED BY ELECTRICAL REMOVAL AND INSTALLATION WORK. NEW TOUCH-UP PAINT WORK SHALL BLEND INTO AND MATCH EXISTING.
- 14. ALL MULTIWIRE BRANCH CIRCUITS SHALL BE IN ACCORDANCE WITH NEC ARTICLE 210.4. ALL CIRCUITS SHALL HAVE INDIVIDUAL NEUTRALS.

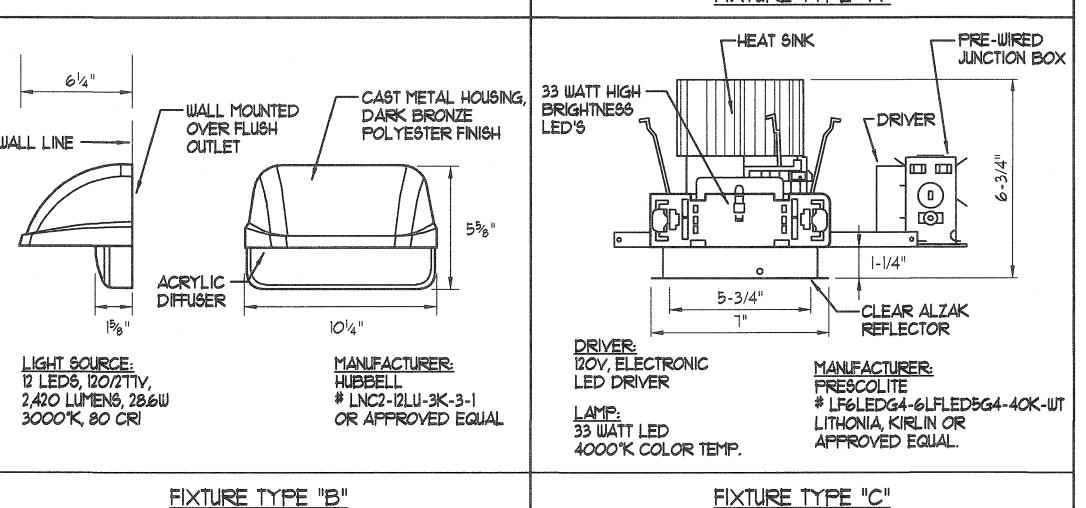

4-13/16"

WALL LINE -

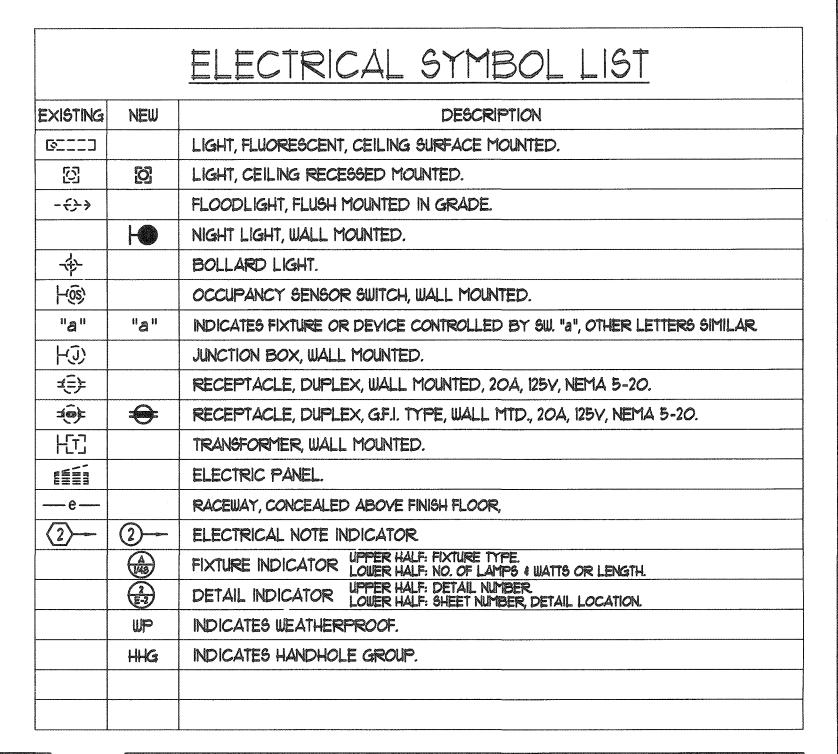

BUILDING ENERGY EFFICIENCY STANDARDS EXTERIOR LIGHTING POWER ALLOWANCE NSTALLED ____246 W

- WALL MOUNTED

OVER FLUSH

ACRYLIC

1-35/64"

<u>LIGHT SOURCE:</u> 5 LEDS, 120/277V

967 LUMENS, 12.8W

3000°K, 80 CRI

DIFFUSER

-CAST METAL HOUSING,

DARK BRONZE

8-7/32"


MANUFACTURER:

LNC-5LU-3K-3-1

OR APPROVED EQUAL

HUBBELL

POLYESTER FINISH

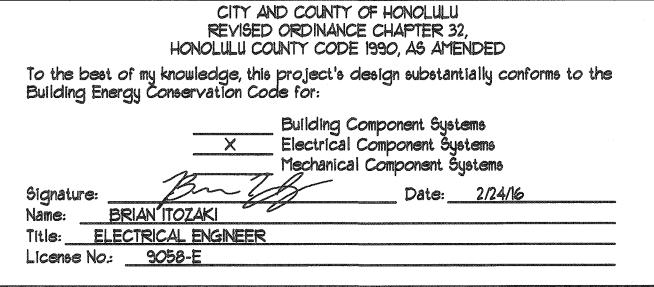




ELPA = ELUPA X GLA

WHERE


ELPA = EXTERIOR LIGHTING POWER ALLOWANCE (W) EULPA : EXTERIOR UNIT LIGHTING POWER ALLOWANCE GLA = GROSS LIGHTED AREA

GLA = GROOD LIGH	LIED ALCEN				
	EULPA	GLA	ELPA	<u>INSTALLED</u>	
PAVILLION	125 W/ft. ²	236 ft. ²	295 W	246 W	
SEATING AREAS	125 W/ft. ²	157 rt. ²	196 W	102 W	
		œ		***************************************	
			491 W	246 W	
	PAVILLION	PAYILLION 125 W/ft. ²	EULPA GLA PAYILLION 125 W/ft. 2 236 ft. 2	EULPA GLA ELPA PAVILLION 125 W/ft. 2 236 ft. 2 295 W SEATING AREAS 125 W/ft. 2 157 ft. 2 196 W	EULPA GLA ELPA INSTALLED PAVILLION 125 W/ft. 2 236 ft. 2 295 W 246 W SEATING AREAS 125 W/ft. 2 157 ft. 2 196 W 102 W

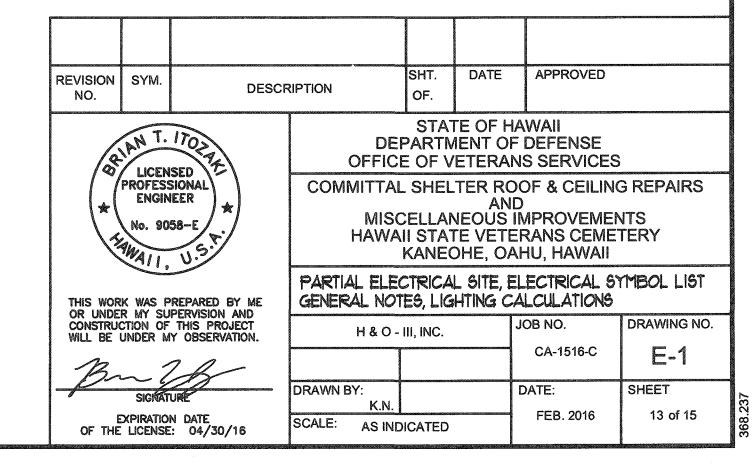


FIXTURE TYPE "A"

FIXTURE TYPE "C"

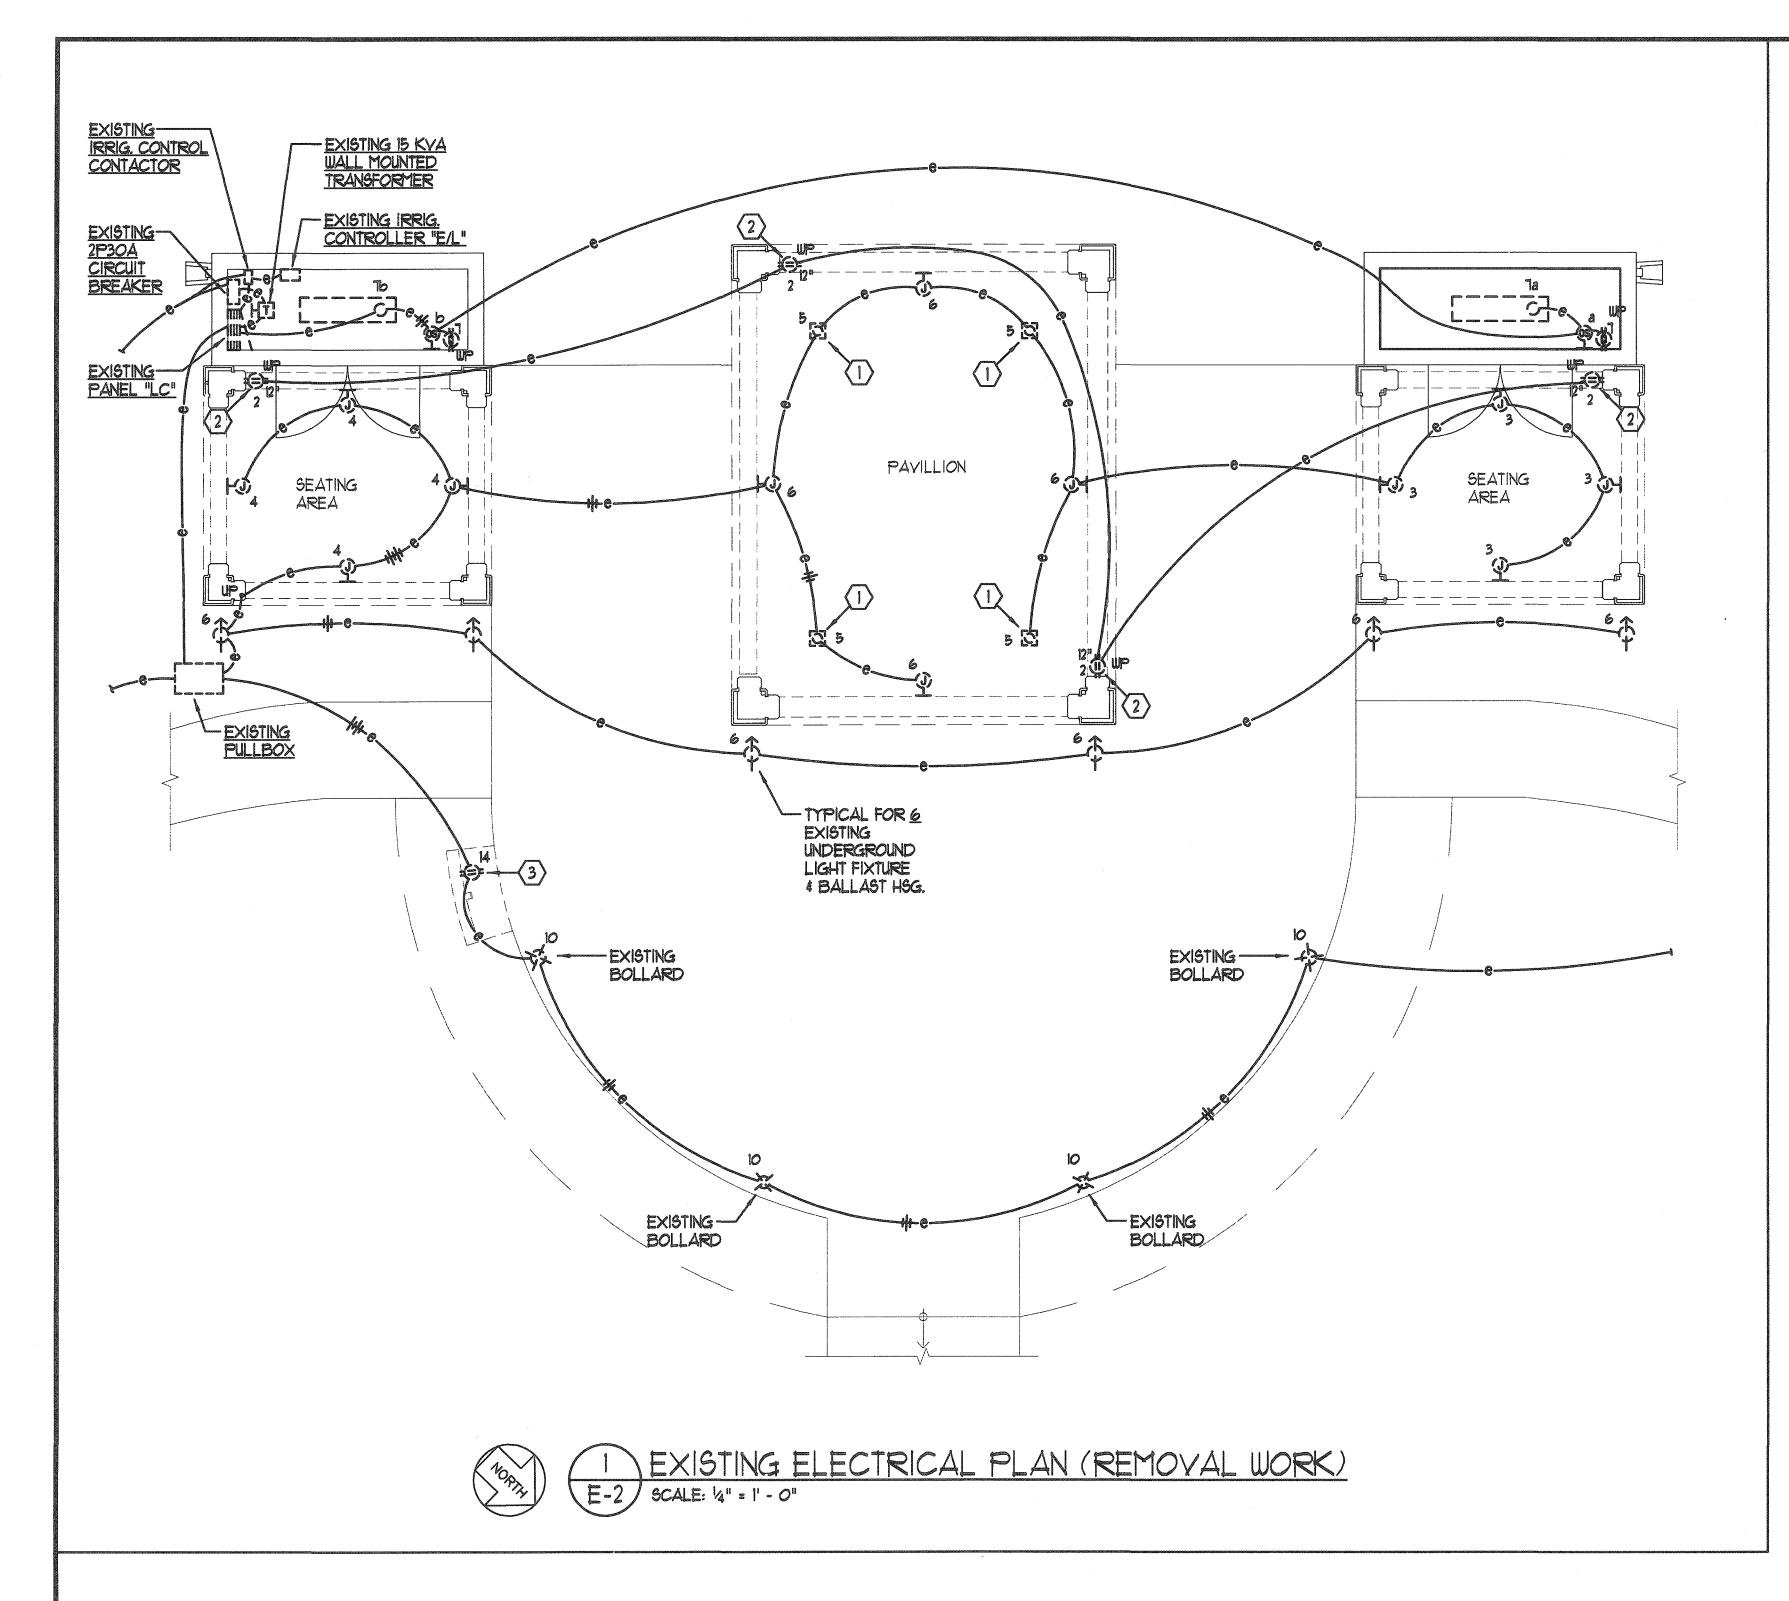

ELECTRICAL NOTES: EXISTING/REMOVAL WORK

- 1) DISCONNECT AND REMOVE CEILING RECESSED LIGHT FIXTURE.
- 2 DISCONNECT AND REMOVE FLUSH MOUNTED RECEPTACLE/PLATE.
- DISCONNECT AND REMOVE OUTLET WITH RECEPTACLE/PLATE.
 INTERCEPT AND CONNECT RACEWAYS. PULL-IN NEW WIRES
 BETWEEN BOLLARD AND PULL BOX.

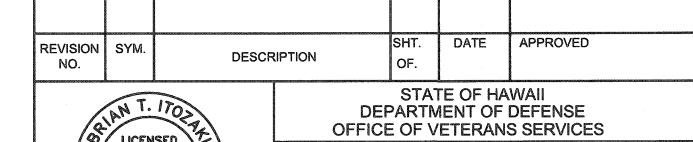

LICENSED PROFESSIONAL engineer

THIS WORK WAS PREPARED BY ME OR UNDER MY SUPERVISION AND CONSTRUCTION OF THIS PROJECT WILL BE UNDER MY OBSERVATION.

COMMITTAL SHELTER ROOF & CEILING REPAIRS

AND

MISCELLANEOUS IMPROVEMENTS


HAWAII STATE VETERANS CEMETERY

KANEOHE, OAHU, HAWAII EXISTING ELECTRICAL PLAN (REMOVAL WORK)

DRAWING NO. H & O - III, INC. E-2 DRAWN BY: SHEET FEB. 2016 14 of 15 EXPIRATION DATE
OF THE LICENSE: 04/30/16 SCALE: AS INDICATED

GRAPHIC SCALE

SCALE: 1/4"=1'-0"

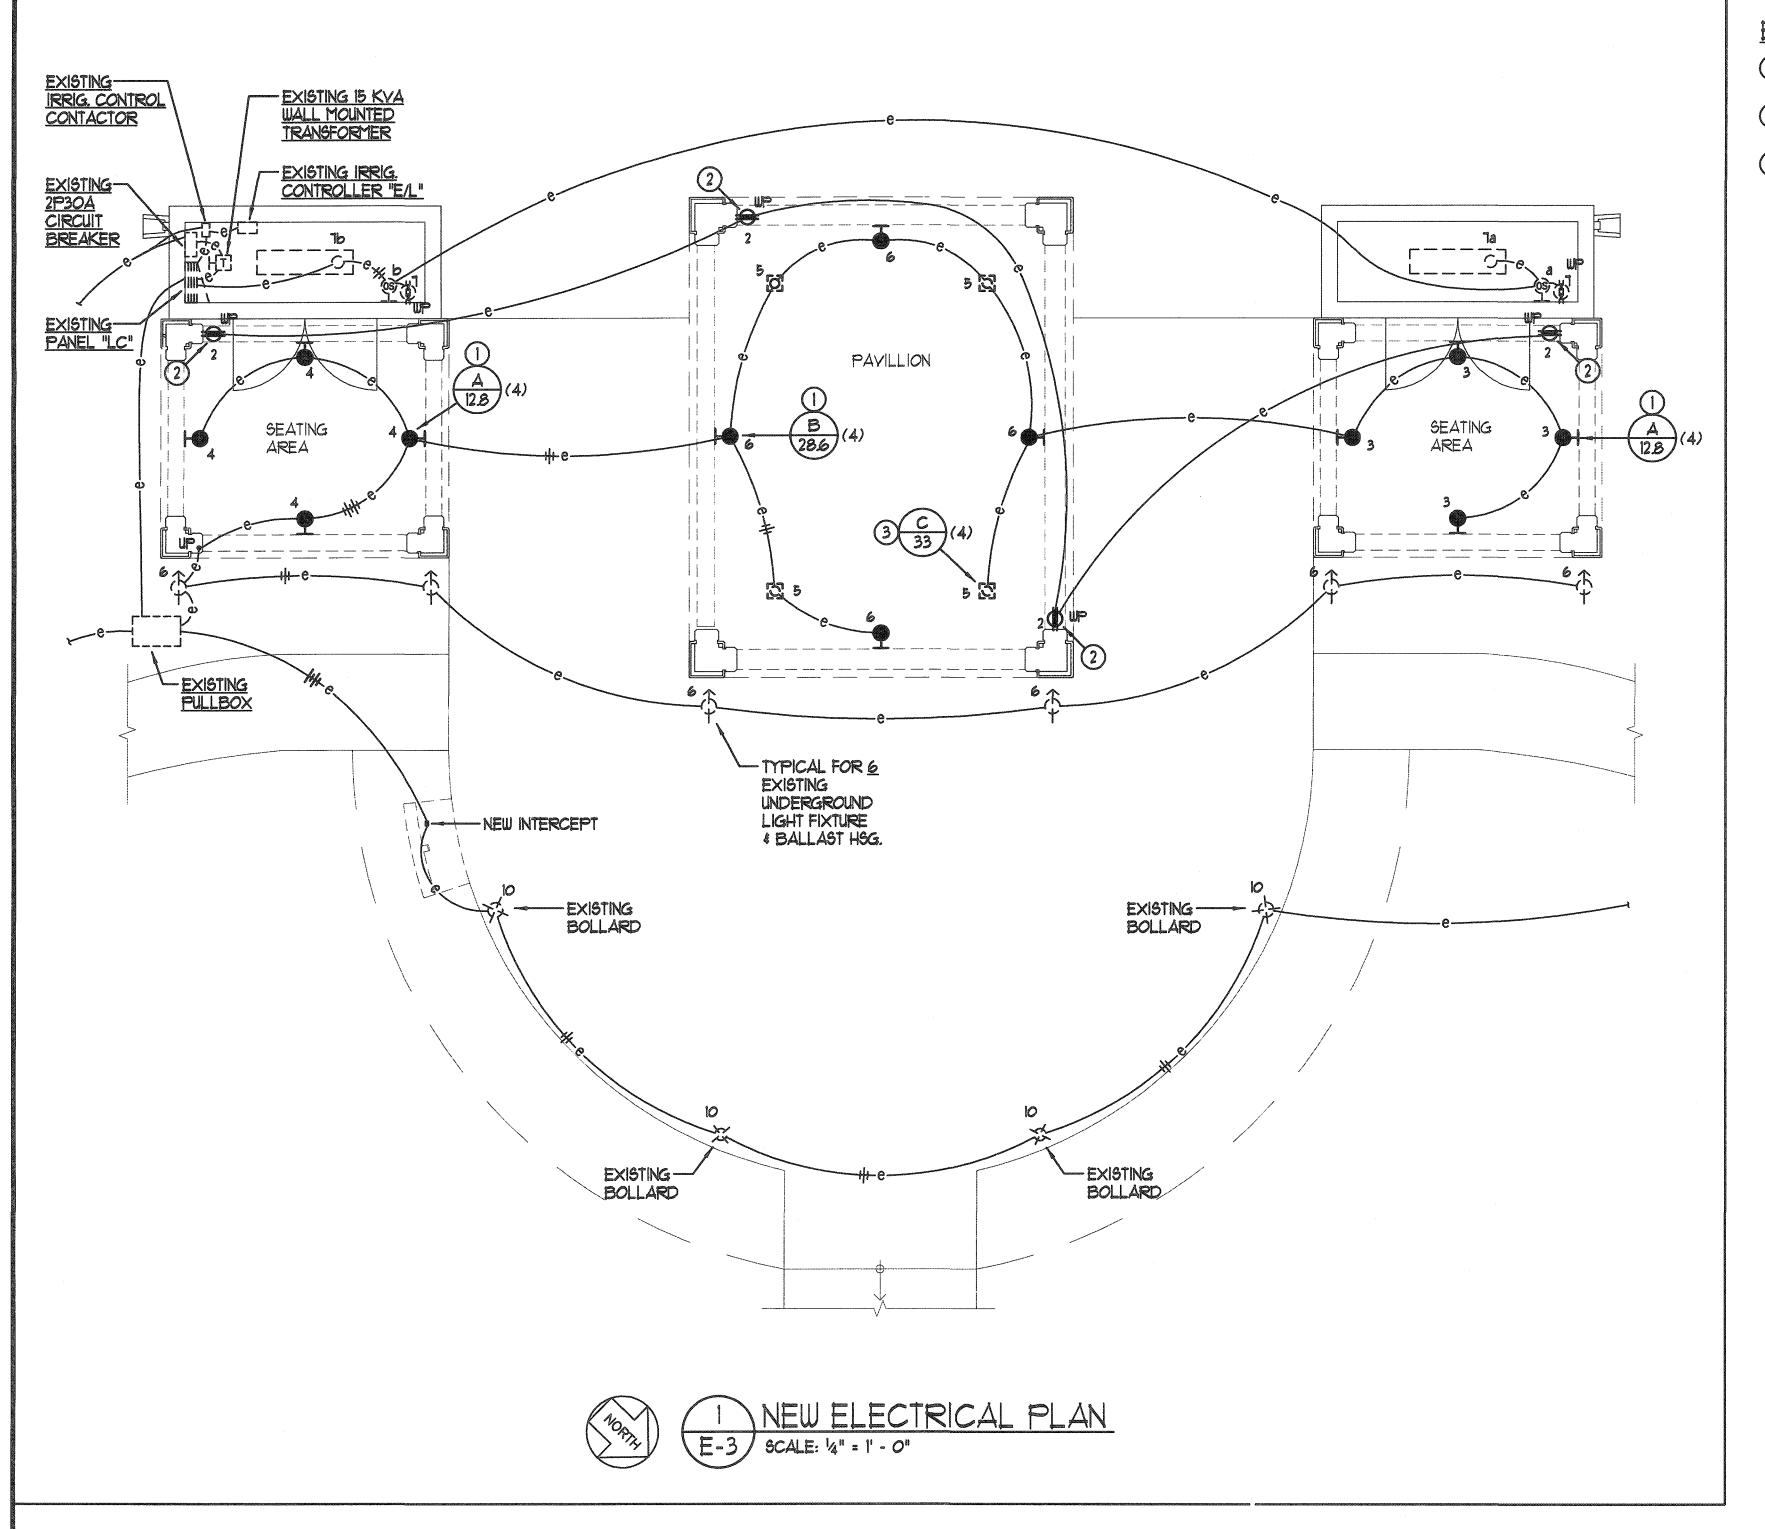

ELECTRICAL NOTES: NEW WORK

- PROVIDE NEW WALL MOUNTED FIXTURE OVER EXISTING FLUSH OUTLET. VERIFY EXISTENCE OF WIRING. IF NOT EXISTING, PROVIDE NEW.
- PROVIDE NEW GFCI RECEPTACLE AND CAST METAL WHILE-IN-USE COVER MOUNT ON EXISTING FLUSH OUTLET BOX. CONNECT TO EXISTING WIRES.
- 3 PROVIDE NEW CEILING RECESSED LIGHTING FIXTURE IN NEW CEILING. SEE ARCH. FOR LOCATION.

REVISION SYM. DESCRIPTION SHT. DATE APPROVED
OF.

STATE OF HAWAII
DEPARTMENT OF DEFENSE
OFFICE OF VETERANS SERVICES



COMMITTAL SHELTER ROOF & CEILING REPAIRS
AND
MISCELLANEOUS IMPROVEMENTS
HAWAII STATE VETERANS CEMETERY
KANEOHE, OAHU, HAWAII

THIS WORK WAS PREPARED BY ME OR UNDER MY SUPERVISION AND CONSTRUCTION OF THIS PROJECT WILL BE UNDER MY OBSERVATION.

SIGNATURE

EXPIRATION DATE
OF THE LICENSE: 04/30/16

 NEW ELECTRICAL PLAN

 H & O - III, INC.
 JOB NO.
 DRAWING NO.

 CA-1516-C
 E-3

 DRAWN BY:
 DATE:
 SHEET

 K.N.
 FEB. 2016
 15 of 15

GRAPHIC SCALE

